W N


15 Lake Road

Town of Chilmark, MA 1 inch = 283 Feet




www.cai-tech.com

March 6, 2024 0 283 566 849

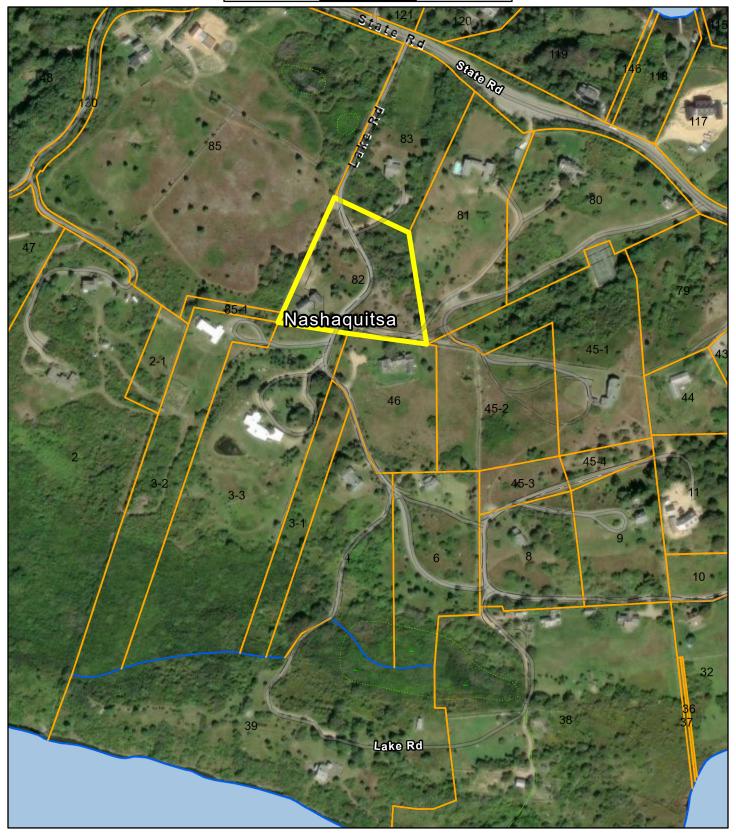

Data shown on this map is provided for planning and informational purposes only. The municipality and CAI Technologies are not responsible for any use for other purposes or misuse or misrepresentation of this map.

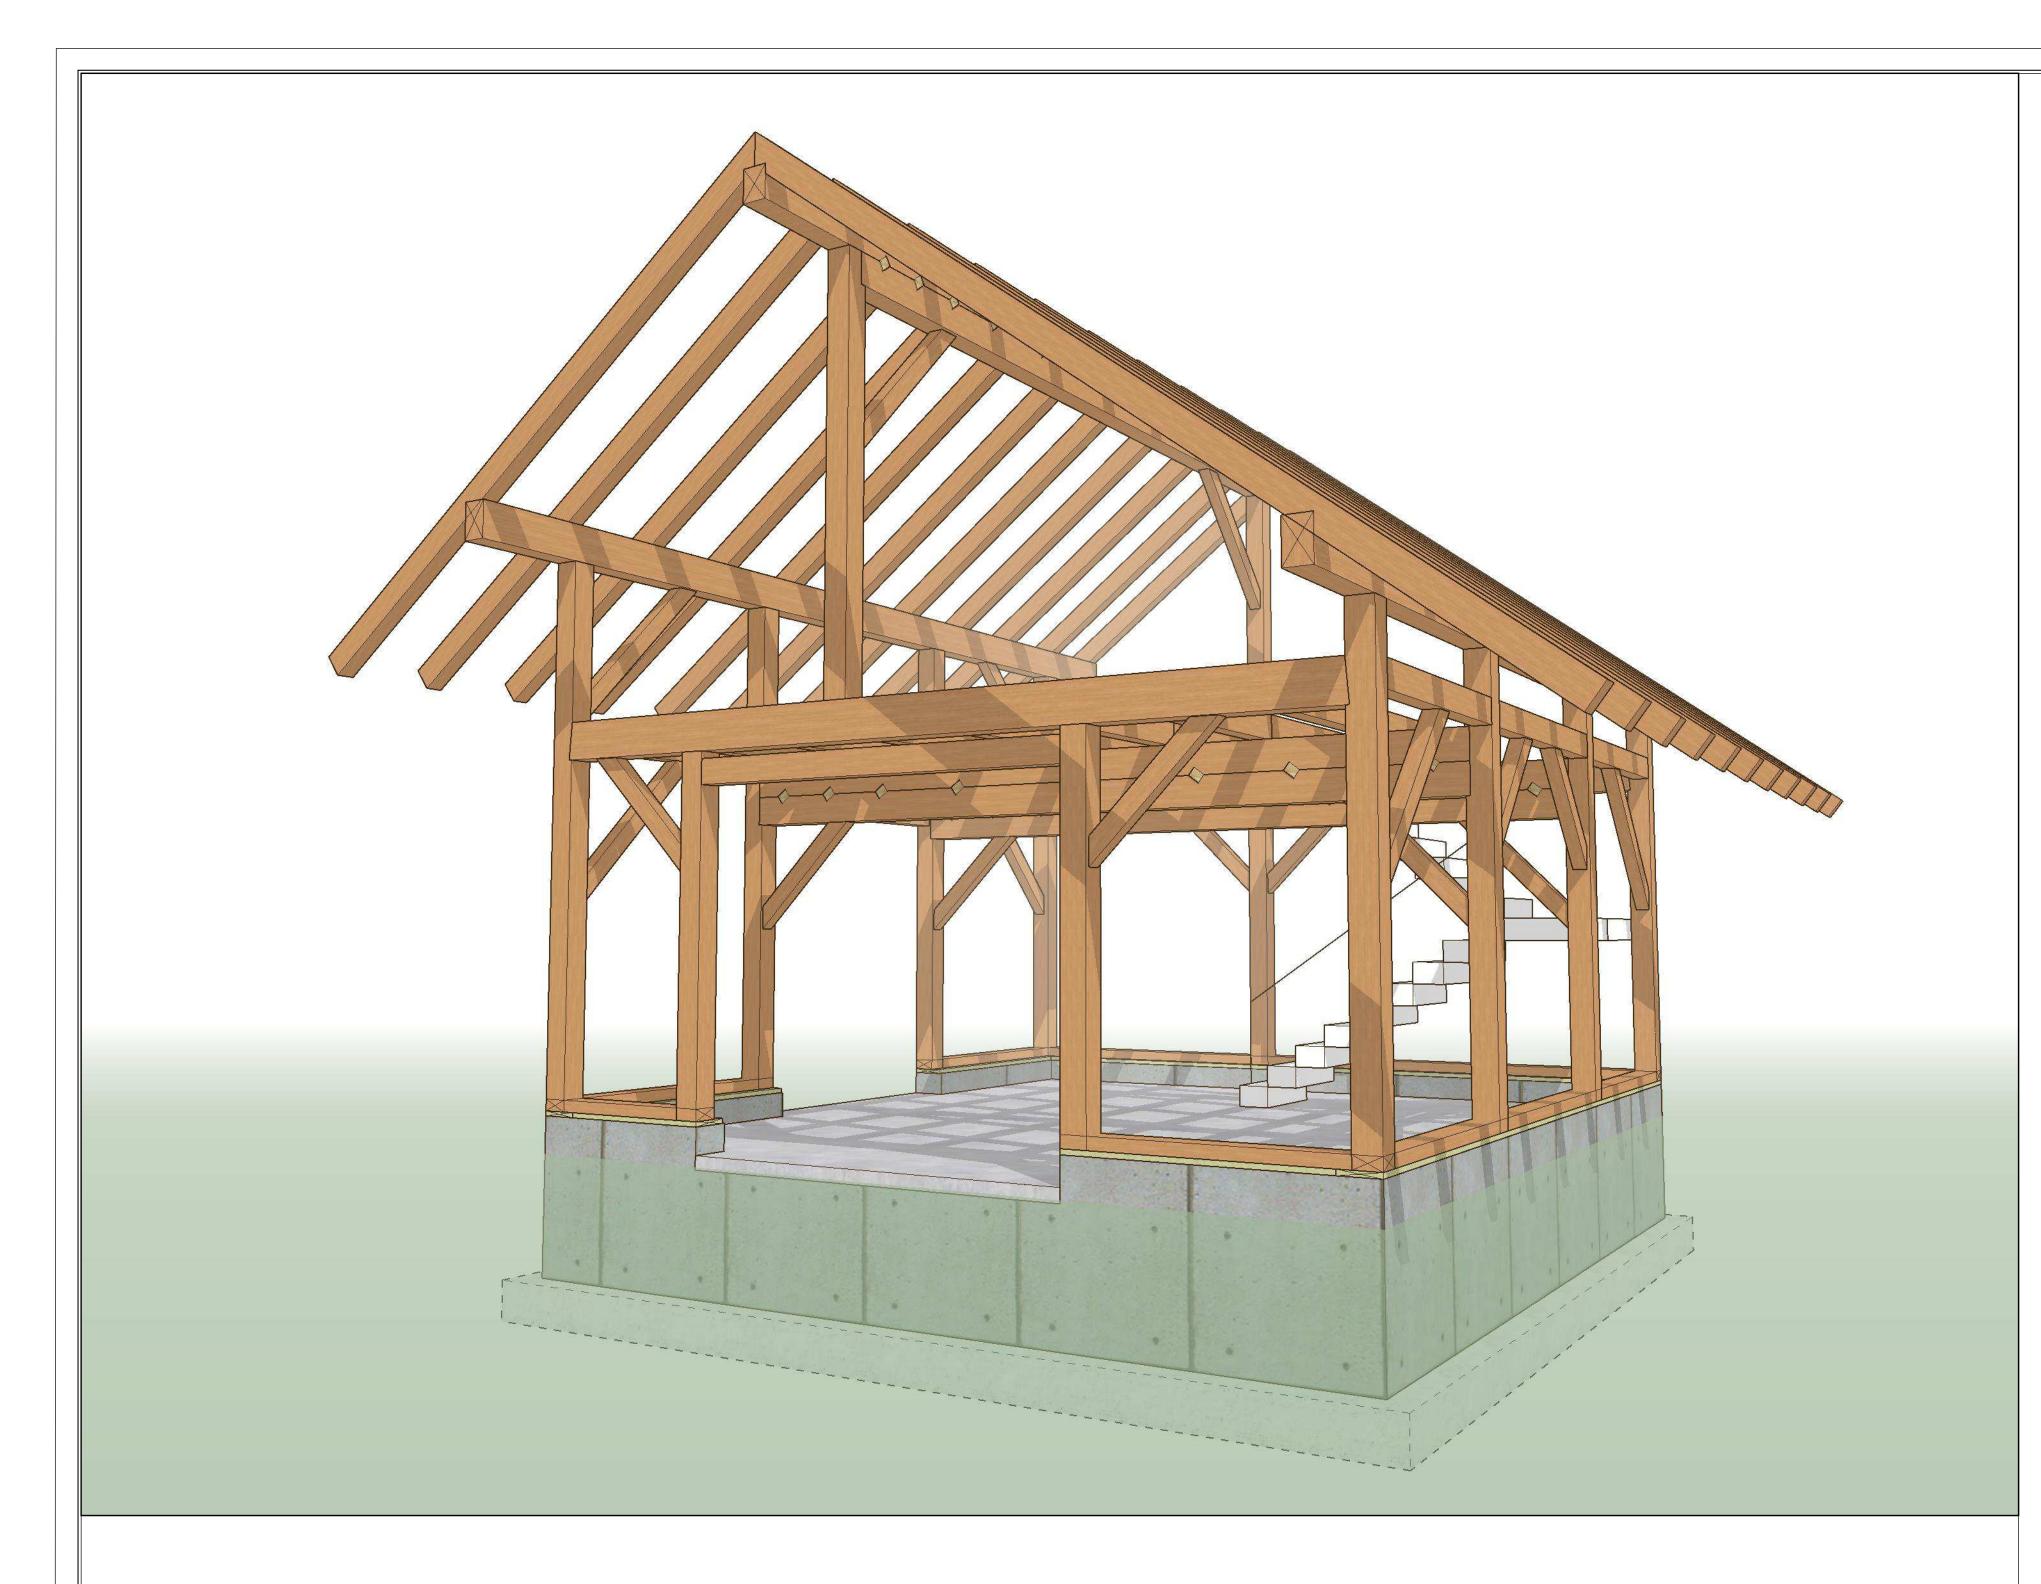

TIMBERFRAME SPECIFICATIONS:

- These drawings depict an exposed, heavy timber framed structure.
- The timbers are EASTERN WHITE PINE, unless noted otherwise. The timbers meet the NEMLA standards for #2 (or better). Their moisture content, at fabrication, is approximately 20%. Some warping, twisting, and checking of timbers is anticipated as they reach equilibrium moisture content.
- The timber sizes shown are NOMINAL. The timber sizes are subject to slight revision; but only under the direct supervision of the ENGINEER OF RECORD for the frame.
- The timber connections are based on traditional methods using mortises, tenons, splines, pegs, and keys. The connections are designed and detailed under the direct supervision of ENGINEER OF RECORD for the frame.
- All timber joinery must be approved by ENGINEER OF RECORD for the frame.
- * All metal connectors (at post feet, for example) are to be Simpson or equal.

TIMBER SCREWS:

- UNLESS NOTED OTHERWISE, ALL SCREWS SHALL BE BY GRK RSS, ROTHOBLAAS TBS, SIMPSON OR OTHER APPROVED SCREW, WITH A SHANK DIAMETER OF AT LEAST 0.2", AND A THREAD DIAMETER OF AT LEAST 0.30".
- SCREWS HOLES SHALL NOT BE PRE-DRILLED UNLESS OTHERWISE NOTED, AND HAVE AT LEAST 3" OF THREAD PENETRATION INTO THE CONNECTING MEMBER.

TIMBER FRAME JOINERY:

- UNLESS OTHERWISE CALLED OUT IN JOINERY DETAILS ON THE STRUCTURAL AND TIMBER FRAME DRAWINGS, THE JOINERY SHOULD MEET THE FOLLOWING REQUIREMENTS, AND BE DETAILED IN ACCORDANCE WITH TFEC 1-19.
- ALL PEGS SHALL BE 1" IN DIAMETER, AND MEET THE REQUIREMENTS OF TFEC 1-19.
- ALL BRACES SHALL BE HELD BY ONE PEG PER JOINT UNLESS NOTED OTHERWISE.
- ALL NON BRACE TENONS SHALL BE HELD WITH (2) PEGS UNLESS NOTED OTHERWISE.
- TENONS CONNECTING MEMBERS IN 8X MATERIAL AND LARGER (SMALLEST DIRECTION), SHALL BE 2" THICK AND 5" IN LENGTH, WITH 3" OF RELISH. IN 6X MATERIAL, 1 $\frac{1}{2}$ " THICK, 4" LONG TENONS WITH 2 $\frac{1}{2}$ " RELISH SHALL BE USED. 4X AND SMALLER MATERIAL, INCLUDING BRACES (UNLESS OTHERWISE CALLED OUT) AND STRUTS, SHALL HAVE A 1 $\frac{1}{2}$ " THICK TENON, AT LEAST 3 $\frac{1}{2}$ " IN LENGTH, AND 2 $\frac{1}{2}$ " OF RELISH.
- WHERE TENON INTERFERENCE OCCURS, TENONS SHALL BE AS LONG AS POSSIBLE, AND OFFSET (HIGH/LOW) WHERE POSSIBLE. IN THREE-WAY AND FOUR-WAY CONNECTIONS, 1 ½" THICK HARDWOOD (SPECIFIC GRAVITY EQUAL TO OR GREATER THAN THE CONNECTING TIMBERS) OR 1 ¾" LVL SPLINES ARE STRONGLY ENCOURAGED.
- HOUSINGS FOR 6X AND LARGER STOCK SHALL BE 1", UNLESS SPECIFIED OTHERWISE. WHERE 6X FRAMING IS NOT DIRECTLY SUPPORTING ROOF OR FLOOR LOADS, 1/2" STUB TENONS MAY BE USED IN PLACE OF FULL 1" HOUSINGS. 4X MATERIAL, INCLUDING BRACES, SHALL BE HOUSED 1/2". BIRDSMOUTHS, REDUCTIONS, AND COPES NOT SUPPORTED BY A BEARING SURFACE SHALL NOT EXCEED MORE THAN 1/4 THE MEMBER DEPTH WITHOUT REQUIRING FURTHER REINFORCEMENT.
- UNLESS OTHERWISE SPECIFIED, RAFTERS AND PURLINS SHALL BE SECURED INTO THEIR HOUSINGS AND SUPPORTS WITH LOG SCREWS, (1) SCREW AT EACH END FOR 6X AND SMALLER MATERIAL, (2) SCREWS AT EACH END FOR 8X AND LARGER MATERIAL.

DESIGN CRITERA:

BUILDING CODES:

IBC 2015 MASSACHUSETTS WITH AMENDMENTS

ASCE 7-10 MINIMUM DESIGN LOADS FOR BUILDINGS

DESIGN LOADS:

DEAD - 15 PSF (assumed)

GROUND SNOW LOAD = 35 PSF, Ct=1.2

NOMINAL WIND SPEED = 101 MPH

ULTIMATE WIND SPEED = 130 MPH

SEISMIC DESIGN CATEGORY = B

FROST DEPTH = 48"
ALLOWABLE SOIL BEARING = 2000 PSF (ASSUMED)

SEE ARCHITECTURAL, MECHANICAL & ELECTRICAL DRAWINGS FOR DIMENSIONS AND DETAILS REQUIRED AS STRUCTURAL WORK, WHICH ARE NOT SHOWN ON THE STRUCTURAL DRAWINGS. ANY DISCREPANCY THAT EXISTS BETWEEN WHAT IS SHOWN AND ACTUAL MUST BE BROUGHT TO THE ATTENTION OF HARDWICK POST & BEAM/ ENGINEER PRIOR TO THE START OF CONSTRUCTION. THE REPRODUCTION OF ANY CONTRACT DOCUMENTS, IN FULL OR IN PART, FOR THEIR USE AS SHOP DRAWINGS WILL NOT BE ACCEPTED AND WILL BE RETURNED AS REJECTED. SUBMITTALS VIA FACSIMILE ARE ALSO UNACCEPTABLE AND WILL NOT BE REVIEWED.

GENERAL NOTES:

- 1. CONTRACTOR SHALL FIELD VERIFY EXISTING CONDITIONS AND IMMEDIATELY NOTIFY THE ENGINEER OF ANY DISCREPANCIES OR OTHER CONDITIONS WHICH DIFFER FROM WHAT IS INDICATED ON THE DRAWINGS.
- 2. DIMENSIONS SHOWN ON STRUCTURAL DRAWINGS SHALL BE VERIFIED BY THE CONTRACTOR WITH THOSE SHOWN ON THE ARCHITECTURAL DRAWINGS. ANY DISCREPANCIES SHALL BE BROUGHT TO THE ATTENTION OF THE DESIGNER AND ENGINEER PRIOR TO CONSTRUCTION.
- 3. CONSTRUCTION MATERIALS SHALL NOT BE PLACED, STACKED OR OTHERWISE STORED UPON ANY STRUCTURAL ELEMENT IN A MANNER WHICH EXCEEDS THE LIVE LOAD CAPACITY OF THE ELEMENT. UNLESS OTHERWISE NOTED, THIS LIVE LOAD CAPACITY IS 40 PSF.
- 4. NOTES, DETAILS AND DIMENSIONS ON INDIVIDUAL DRAWINGS SHALL TAKE PRECEDENCE OVER GENERAL STRUCTURAL NOTES AND TYPICAL DETAILS. ANY DISCREPANCIES SHALL BE BROUGHT TO THE ENGINEERS ATTENTION BEFORE PROCEEDING WITH CONSTRUCTION.
- 5. THE CONTRACTOR SHALL BE SOLEY RESPONSIBLE FOR PROVIDING ALL MEASURES NECESSARY TO PROTECT THE STRUCTURE DURING ALL PHASES OF CONSTRUCTION. SUCH MEASURES SHALL INCLUDE, BUT ARE NOT NECESSARILY LIMITED TO, TEMPORARY BRACING/SHORING AGAINST WIND, SNOW, EQUIPMENT, MATERIAL STORAGE AND/OR OTHER LOADS WHICH MAY ARISE PRIOR TO THE COMPLETION OF CONSTRUCTION. PERIODIC INSPECTIONS BY THE STRUCTURAL ENGINEER SHALL NOT INCLUDE INSPECTION OF THESE ITEMS NOR ANY OPINION REGARDING THE ADEQUACY OF SUCH MEASURES.
- 6. TIMBER FRAME ELEMENTS HAVE BEEN DESIGNED TO RESIST GRAVITY LOAD ONLY. ALL LATERAL LOADS TO BE CARRIED IN BUILDING ENVELOPE BY OTHERS.

CONCRETE NOTES:

- CONCRETE SHALL COMPLY WITH THE PROVISIONS OF THE AMERICAN CONCRETE INSTITIUTE (ACI) 301 "SPECIFICATIONS FOR STRUCTURAL CONCRETE FOR BUILDINGS", ACI 318 "BUILDING CODE REQUIREMENTS FOR STRUCTURAL CONCRETE".

 REINFORCING STEEL SHALL COMPLY WITH THE CONCRETE REINFORCING STEEL INSTITUTE (CRSI) "MANUAL OF STANDARD PRACTICE" EXCEPT WHERE MORE STRINGENT REQUIREMENTS ARE INDICATED.
- 2. CONCRETE SHALL HAVE A MINIMUM COMPRESSIVE STRENGTH OF 3000 PSI AT 28 DAYS, AND A MAXIMUM WATER-CEMENT RATIO OF 0.46. CONCRETE EXPOSED TO DE-ICING SALTS SHALL FORMULATED USING AIR ENTRAINING ADMIXTURES PROVIDING NOT LESS THAN 4.5 PERCENT NOR MORE THAN 7.0 PERCENT ENTRAINED AIR. AIR ENTRAINING ADMIXTURES SHALL CONFORM TO ASTM C260.
- 3. CONCRETE DESIGN MIX SHALL BE PROPORTIONED SUCH THAT CONCRETE SLUMP, AT THE POINT OF PLACEMENT, SHALL BE NO LESS THAN 1 INCH NOR MORE THAN 3 INCHES FOR REINFORCED STRUCTURAL CONCRETE, 4 INCHES FOR ALL OTHER CONCRETE. WATER SHALL NOT BE ADDED TO THE CONCRETE BEFORE PLACEMENT UNLESS PRIOR APPROVAL IS RECEIVED IN WRITING FROM THE STRUCTURAL ENGINEER.
- 4. CONCRETE SLABS ON GRADE SHALL BE PLACED OVER A VAPOR BARRIER LAPPED A MINIMUM OF SIX INCHES AND SEALED.
- 5. CONCRETE SHALL BE CONSOLIDATED USING VIBRATORY EQUIPMENT AND/OR HAND RODDING AND TAMPING UNTIL CONCRETE IS UNIFORMLY DISTRIBUTED AROUND REINFORCEMENT AND OTHER EMBEDDED ITEMS.
- 6. CONTRACTOR SHALL PROTECT CONCRETE FROM PHYSICAL DAMAGE OR REDUCED STRENGTH DURING MIXING, PLACEMENT AND CURING. COLD WEATHER CONCRETE PLACEMENT SHALL COMPLY WITH ACI 306.
- 7. CONCRETE REINFORCEMENT SHALL BE GRADE 60 STEEL MEETING THE REQUIREMENTS OF ASTM A615 EXCEPT FOR STIRRUPS AND TIES WHICH MAY BE GRADE 40 STEEL.
- 8. REINFORCEMENT SHALL NOT BE SPLICED NOR WELDED EXCEPT AS DETAILED OR AS AUTHORIZED IN WRITING BY THE STRUCTURAL ENGINEER. LAP SPLICES SHALL BE A MINIMUM OF 40 BAR DIAMETERS UNLESS OTHERWISE NOTED ON THE DRAWINGS. HORIZONTAL REINFORCEMENT IN WALLS SHALL BE SPLICED USING CORNER BARS OF EQUAL SIZE AND SPACING AROUND ALL CORNERS AND AT ALL INTERSECTIONS.
- 9. VERTICAL REINFORCEMENT SHALL BE DOWELLED INTO FOUNDATION. DOWELS SHALL TERMINATE WITH A STANDARD HOOK NOT LESS THAN SIX INCHES OR 12 BAR DIAMETERS, WHICHEVER IS GREATER.
- 10. WELDED WIRE FABRIC SHALL CONFORM TO THE REQUIREMENTS OF ASTM A185. LAP WIRE FABRIC A MINIMUM OF ONE FULL
- MESH PLUS 2 INCHES AT SIDES AND ENDS AND TIE TOGETHER.

 11. PROVIDE CLEAR CONCRETE COVER OVER REINFORCEMENT AS FOLLOWS:
- CONCRETE NOT EXPOSED TO WEATHER OR IN CONTACT WITH GROUND1-1/2"
- 12. ANCHOR BOLTS SHALL CONFORM TO ASTM A307. EXPANSION BOLTS SHALL BE HILTI KWIK BOLTS OR APPROVED EQUIVALENT. EXPANSION BOLTS SHALL BE INSTALLED PER MANUFACTURER'S WRITTEN INSTRUCTIONS. WHERE EMBEDMENT LENGTH, EDGE DISTANCE(S) AND/OR SPACING REQUIREMENTS OF THE MANUFACTURER CANNOT BE MET, EPOXY ANCHORS SHALL BE USED.
- 13. NON SHRINK GROUT SHALL BE 5000 PSI FIVE STAR GROUT OR APPROVED EQUAL, INSTALLED PER MANUFACTURER'S WRITTEN
- 14. ANCHOR BOLTS SHALL BE 1/2" DIA. WITH A MINIMUM EMBEDMENT LENGTH OF 8 INCHES. ANCHOR BOLTS SHALL BE INSTALLED AT 48" O.C. AND WITHIN 12 INCHES OF EACH END OF FOUNDATION SILL PLATES. SILL PLATES SHALL BE SECURED TO FOUNDATION WITH NUT & WASHERS.
- 5. CONCRETE SLABS ON GRADE SHALL HAVE W2.9xW2.9 6x6 WWF REINFORCEMENT CENTERED IN SLAB OR #4's @ 16" EA. WAY, CENTERED.

HARDWICK POST & BEAM

P.O. BOX 225
HARDWICK, MA 01037
Ph: (413) 477-6430
FAX: (413) 477-0937
LIC. NO. 010089
WWW.HARDWICKPOSTANDBEAM.COM

PROPOSED PROJECT:

LEE GARAGE

CLIENT:

LEE, BARBARA 15 LAKE ROAD CHILMARK, MA

SITE INFO:

DEPINO / LEE CHILMARK / 15 LAKE ROAD

FI	LE NAME:	HP&B BARBARA	ALEE_CDS_06
D	ATE MODIFIEI	D :	03-20-24
DI	RAWN BY:		GM
CI	HECKED BY:		XXX
so	CALE:		VARIES

ALL MATERIAL IS #1 OR BETTER. EASTERN WHITE PINE.

		ABE	BREVIATIONS			Ç	SHEET INDEX
						ARCH	ITECTURAL DRAWINGS
@ & AFF. ALUM. BB CAB. CF CMU COL. CONC. DF DIA.	AT AND ABOVE FINISH FLOOR ALUMINUM BLUEBOARD CABINET CUBIC FEET CONCRETE MASONRY UNIT COLUMN CONCRETE DOUGLAS FIR DIAMETER	EXP. FD FFE FT GFI. GL GLB. GWB ICF INS. LVL O.C.	EXPOSED FIXED FINISH FLOOR ELEVATION FULLY THREADED GROUND FAULT INTERRUPTER GLASS GLUED LAMINATED BEAM GYPSUM WALL BOARD INSULATED CONCRETE FORM INSULATION LAMINATED VENEER LUMBER ON CENTER	REF. R.O. SD SECT. SHT. SIM. SPF SQ. SQFT STL SYP T&G	REFRIGIERATOR ROUGH OPENING SMOKE DETECTOR SECTION SHEET SIMILAR SPRUCE, PINE, OR FIR SQUARE SQUARE SQUARE FEET STEEL SOUTHERN YELLOW PINE TONGUE & GROOVED	G0 TF1 TF2 TF3 TF4 TF5 TF6 TF7 TF8	COVER PAGE EXTERIOR ELEVATIONS FOUNDATION PLAN PLANVIEW ROOF PLAN LOFT FRAMING PLAN ELEVATION A ELEVATION C ELEVATION E
DN	DOWN DISHWASHER	PLY PVC	PLYWOOD	TBD TYP.	TO BE DETERMINED	TF9	BENT 1
DW EA.	EACH	PVC	POLY VINYL CHLORIDE PARTIALLY THREADED	VB	TYPICAL VAPOR BARRIER	TF10	BENT 2
EL.	ELEVATION	P.T.	PRESSURE TREATED	VIF	VERIFY IN FIELD	TF11	BENT 3

WD WOOD


NO.	REVISIONS	DATE
1	CONCEPT	07-18-23
2	DAMROTH COMMENTS	08-08-23
3	KEYED BEAMS	09-27-23
4		


COVER PAGE

PAGE NUMBER

TF12 BENT 4

G0

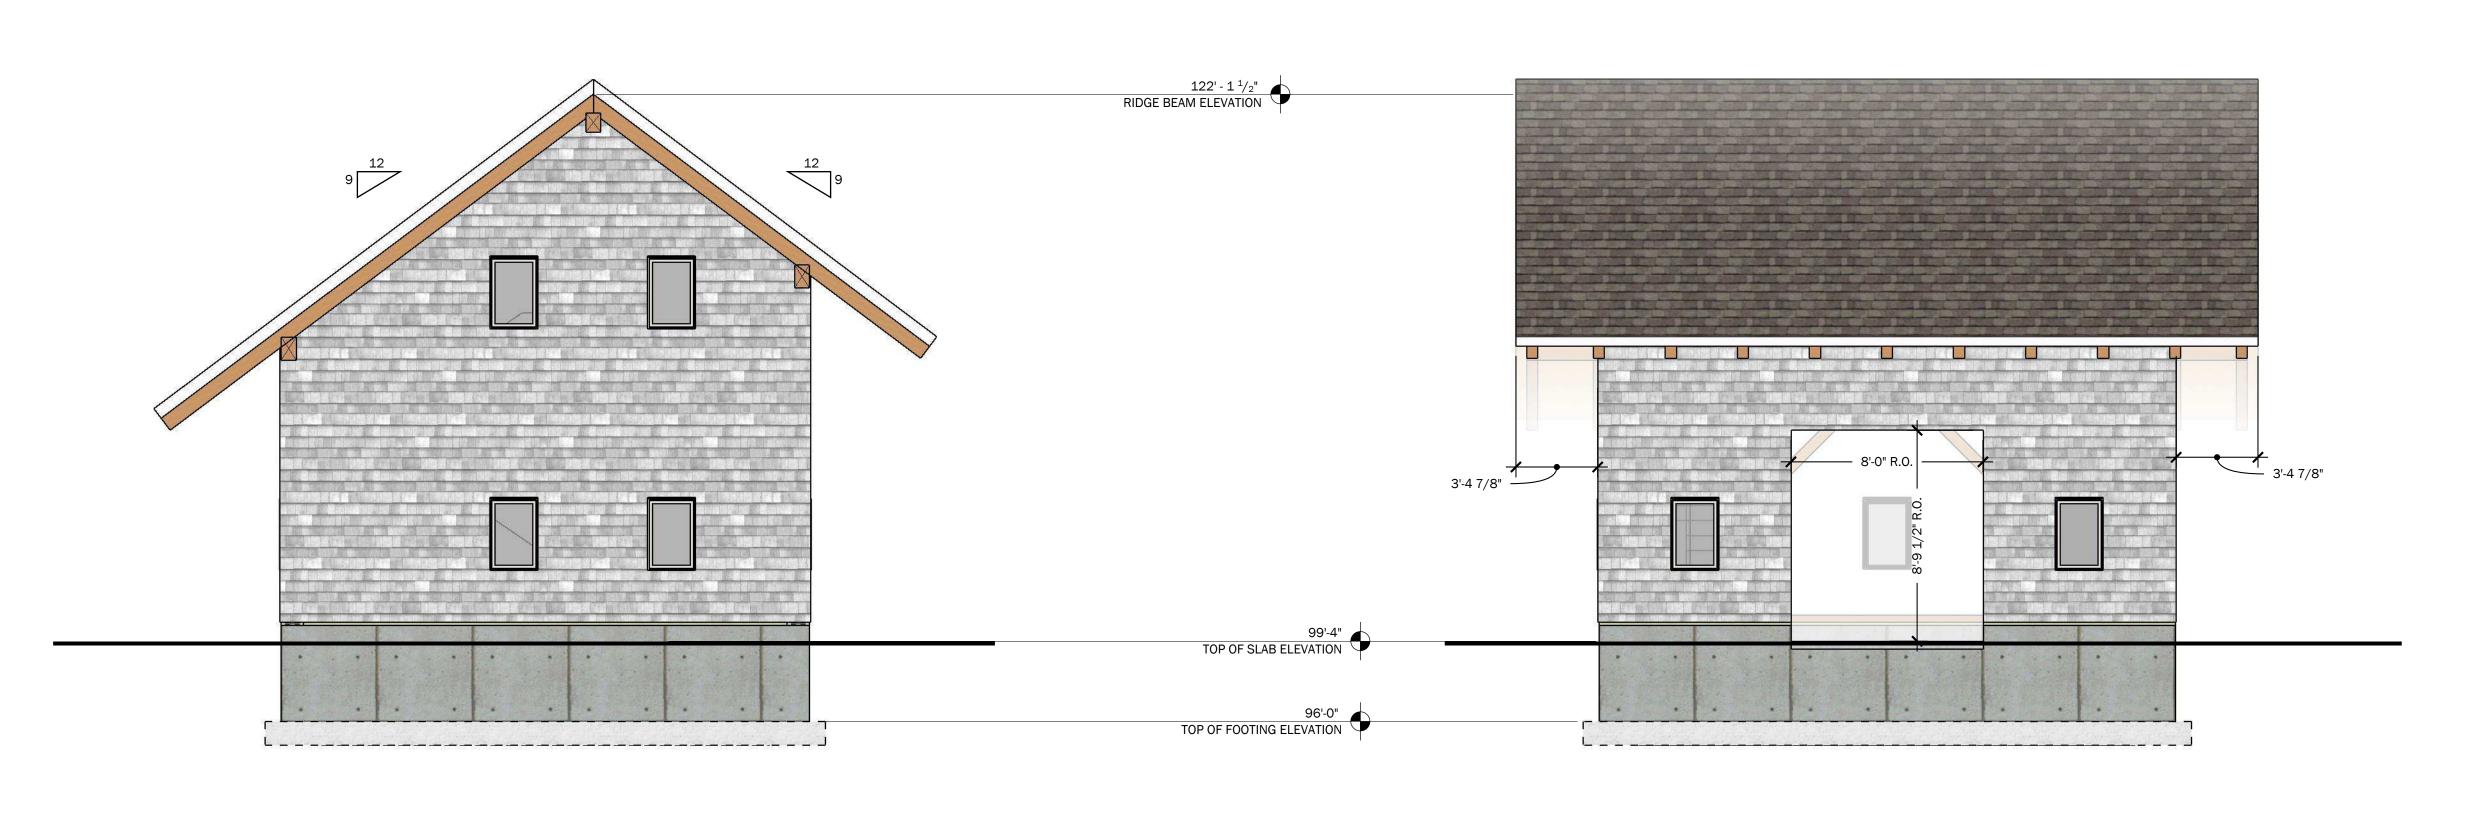

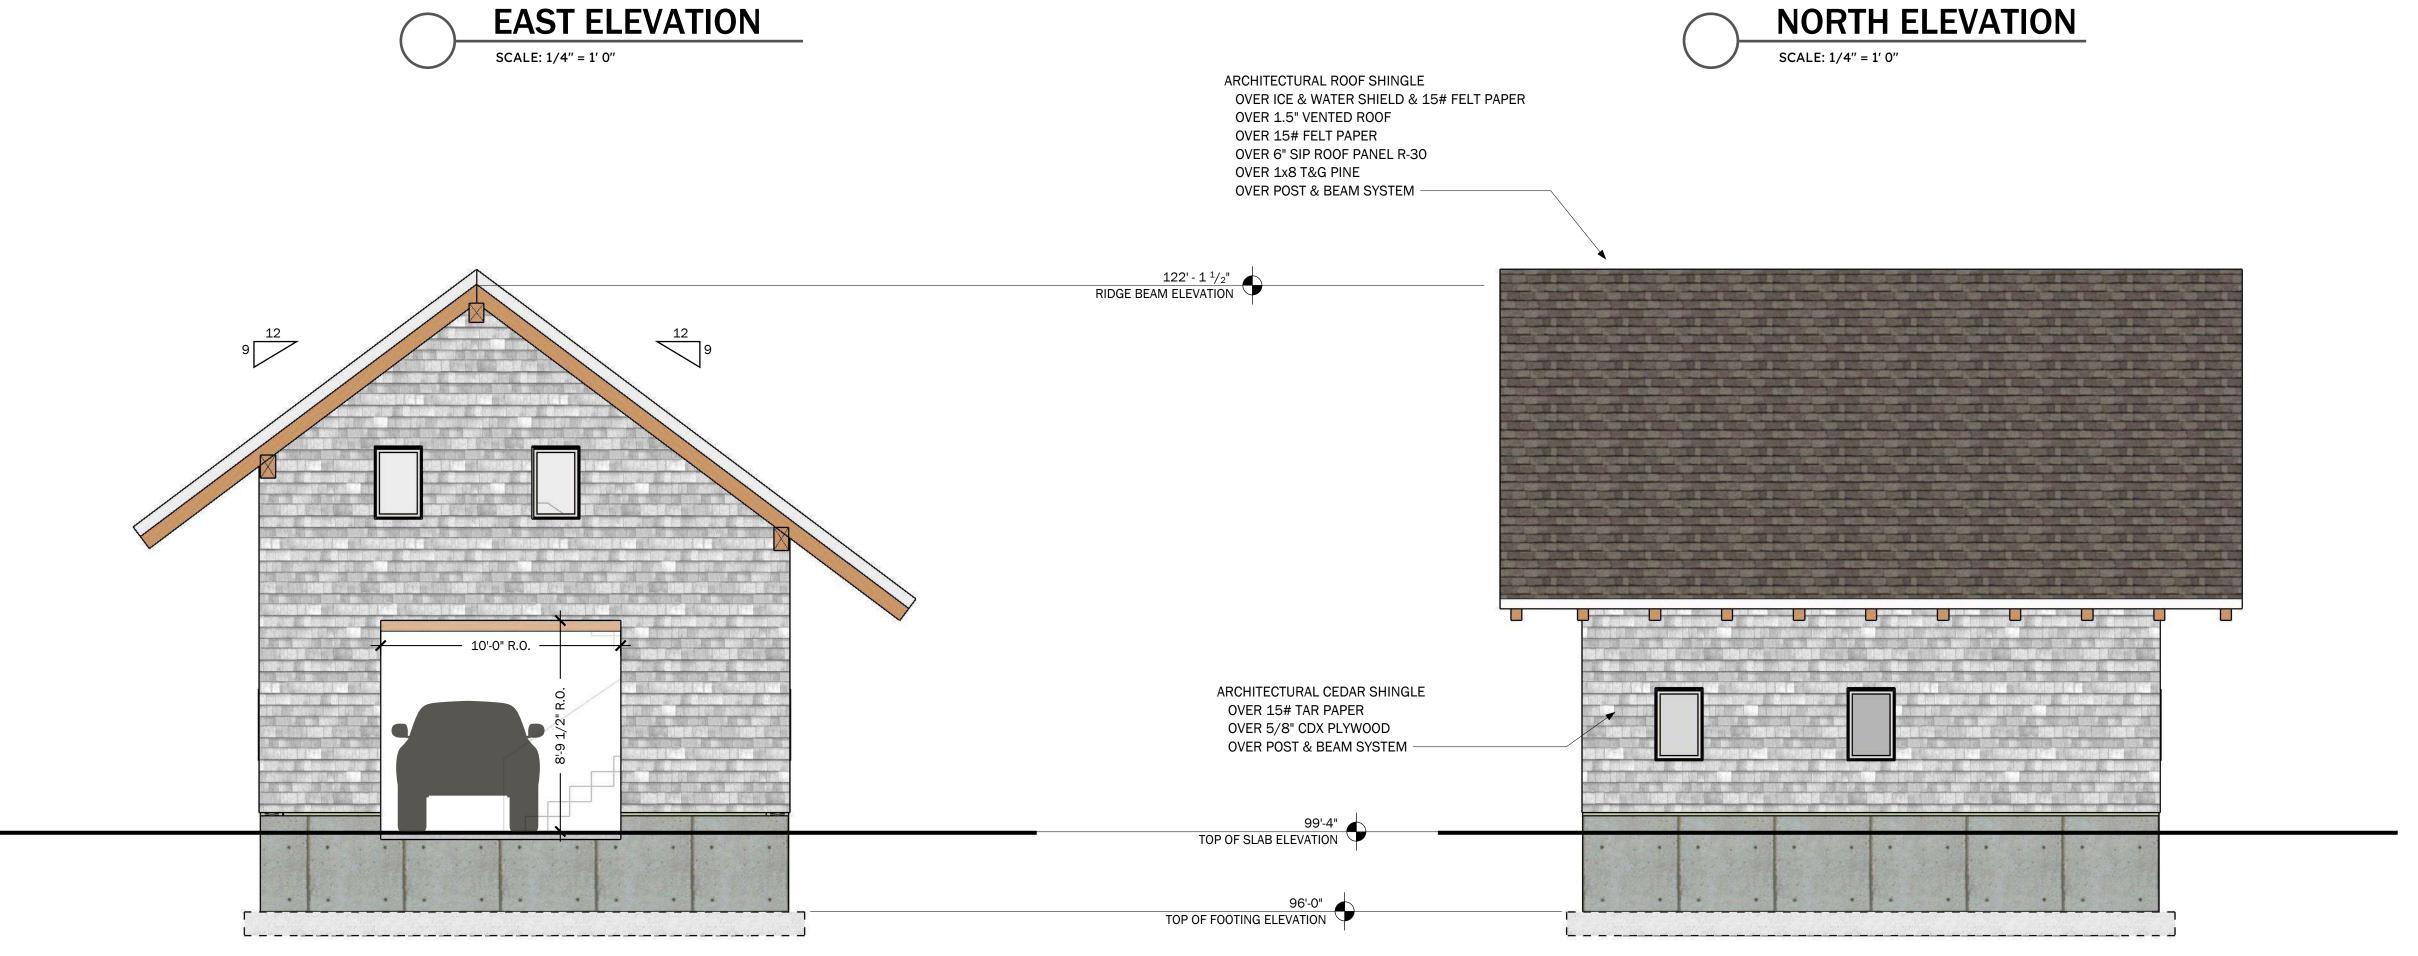

ELEVATION GRADES AND FOUNDATION DROPS SHOWN ARE CONCEPTUAL. FOUNDATION DROPS AND GRADE WILL BE DETERMINED ON SITE BY CONTRACTOR.

SCALE: 1/4" = 1' 0"





P.O. BOX 225
HARDWICK, MA 01037
Ph: (413) 477-6430
FAX: (413) 477-0937
LIC. NO. 010089
WWW.HARDWICKPOSTANDBEAM.COM

PROPOSED PROJECT:

LEE GARAGE

CLIENT:

LEE, BARBARA 15 LAKE ROAD CHILMARK, MA

SITE INFO:

DEPINO / LEE CHILMARK / 15 LAKE ROAD

FILE	NAME:	HP&B BARBAR	RALEE_CDS_06
DAT	E MODIFIEI	D :	03-20-24
DRA	WN BY:		GM
CHE	CKED BY:		XXX
SCA	LE:		VARIES


ALL MATERIAL IS #1 OR BETTER.
EASTERN WHITE PINE.

NO.	REVISIONS	DATE
1	CONCEPT	07-18-23
2	DAMROTH COMMENTS	08-08-23
3	KEYED BEAMS	09-27-23
4		

EXTERIOR ELEVATIONS

PAGE NUMBER

TF1 of 12

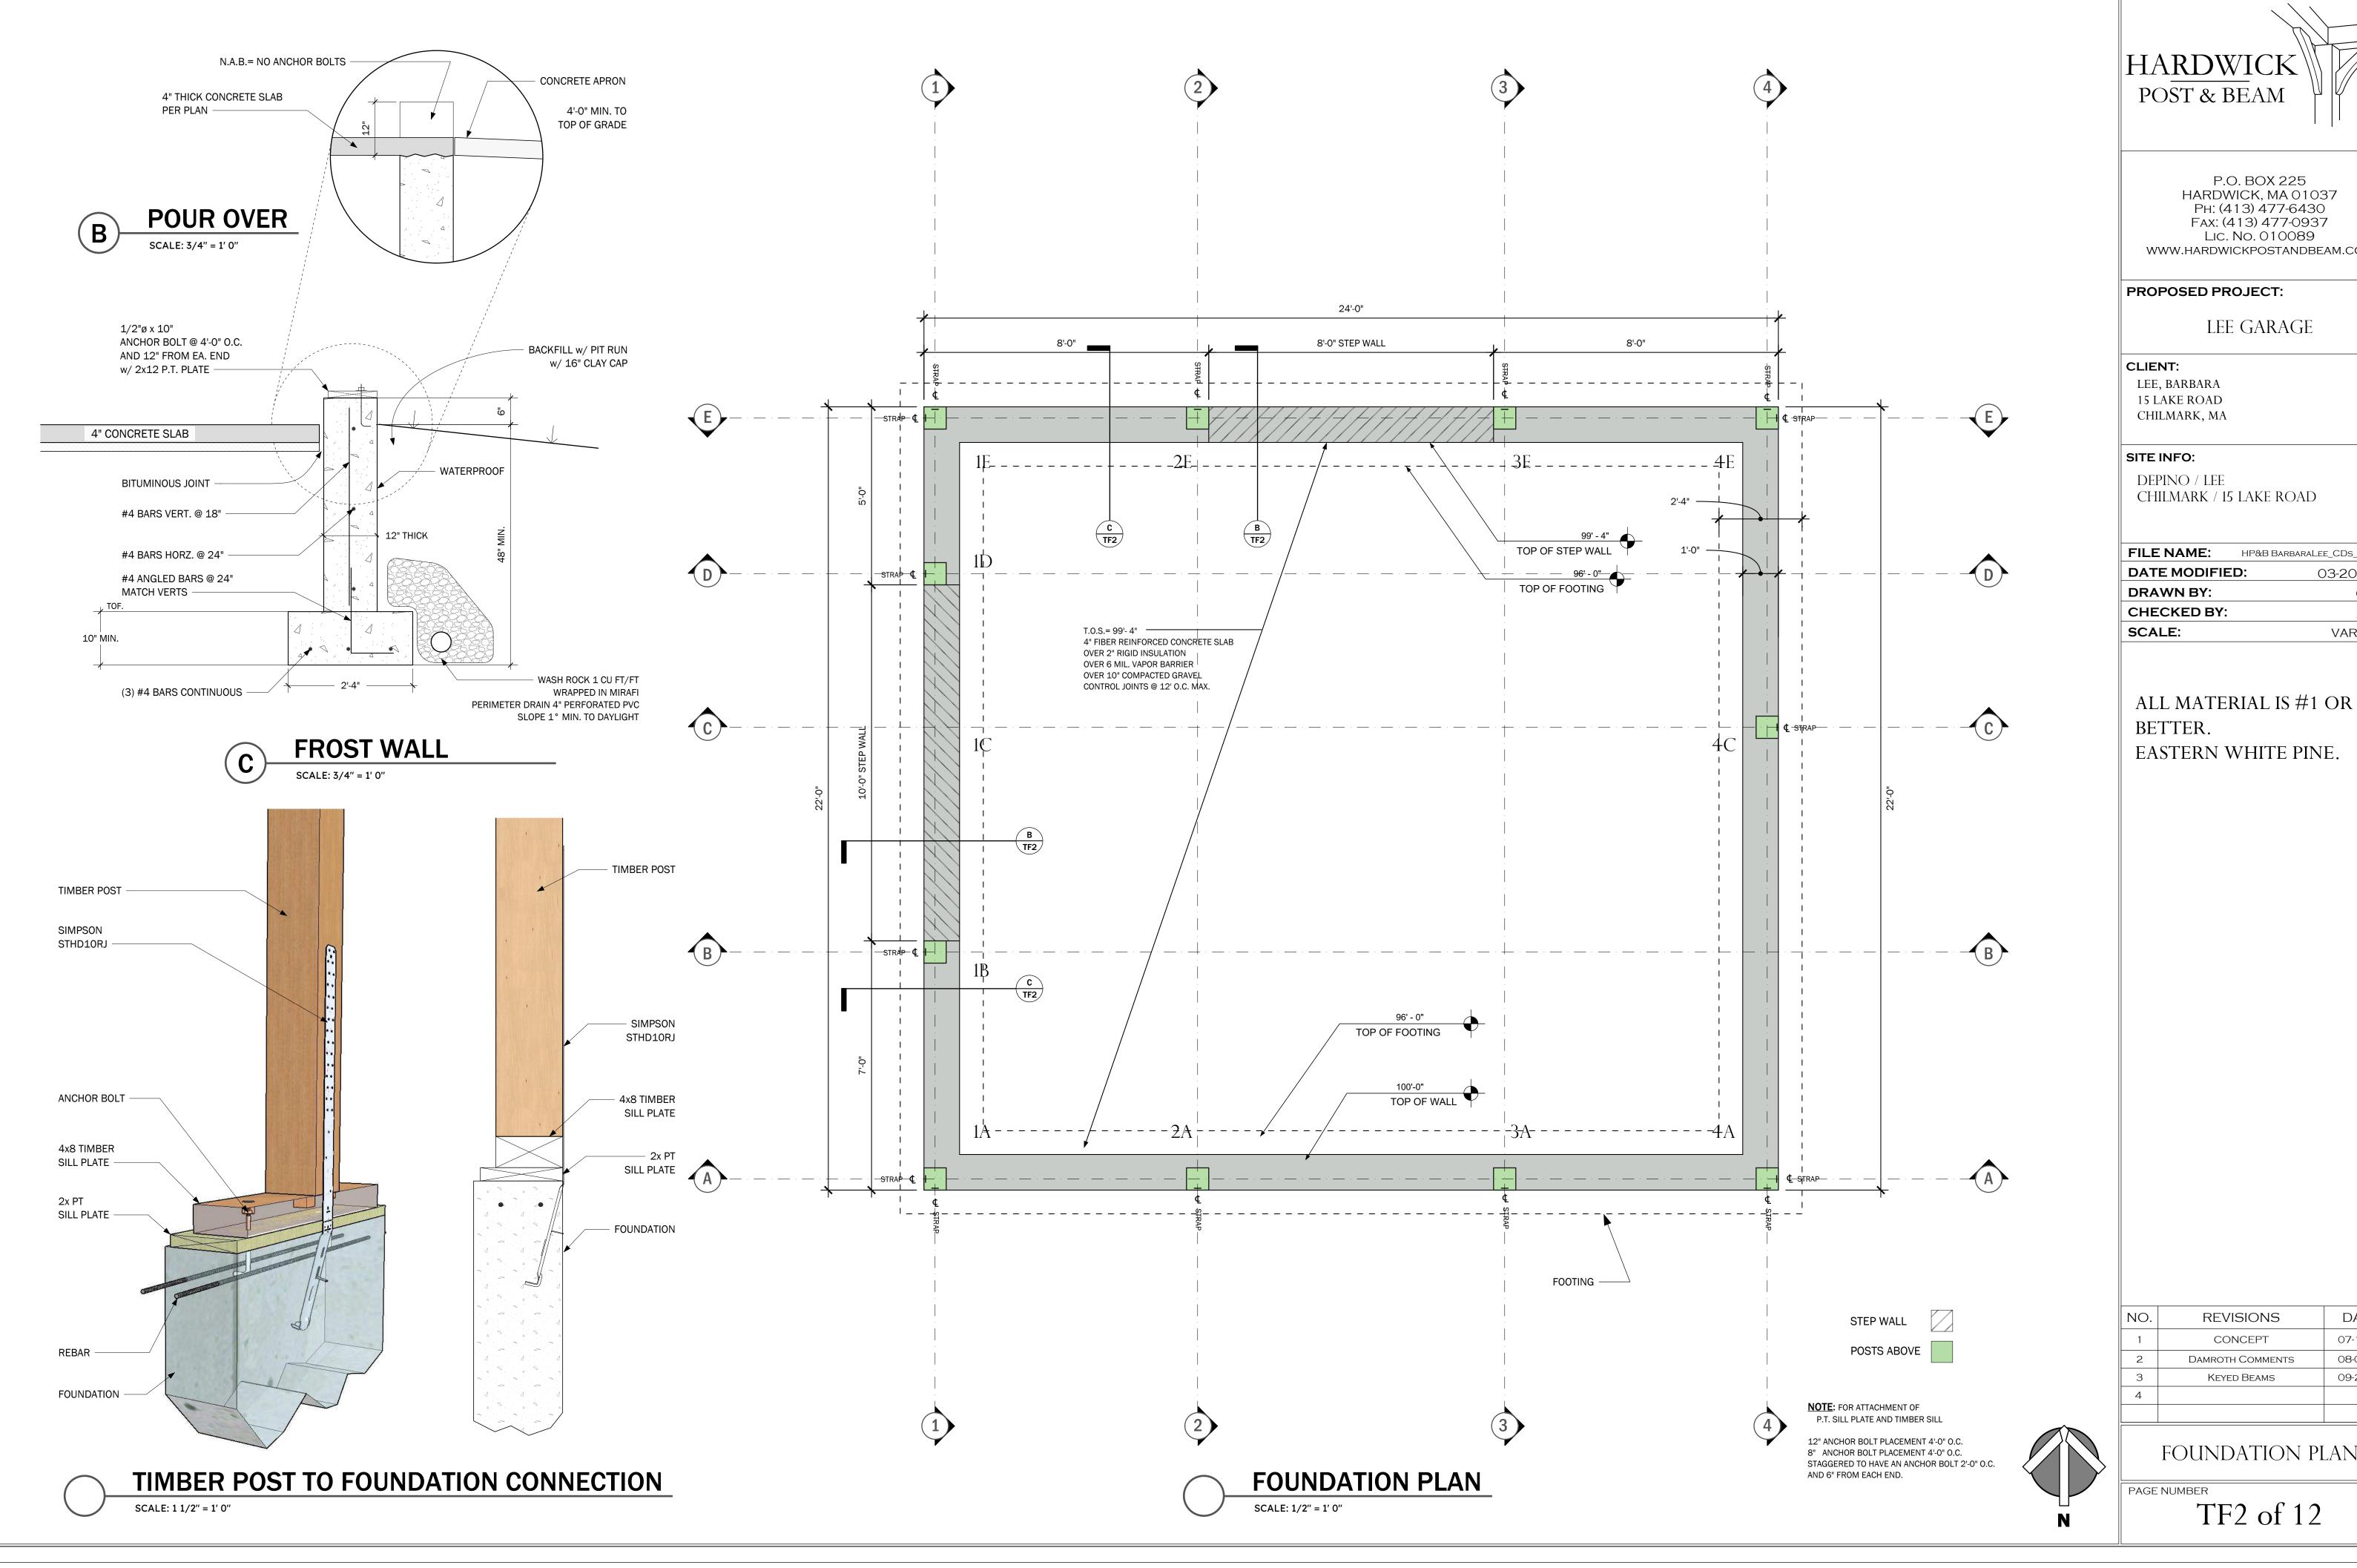



P.O. BOX 225 HARDWICK, MA 01037 PH: (413) 477-6430 Fax: (413) 477-0937 Lic. No. 010089 WWW.HARDWICKPOSTANDBEAM.COM

CHILMARK / 15 LAKE ROAD


FILE NAME:	HP&B BARBARALEE_CDs_06
DATE MODIFIED	03-20-24
DRAWN BY:	GM
CHECKED BY:	XXX
SCALE:	VARIES

EASTERN WHITE PINE.

NO.	REVISIONS	DATE
1	CONCEPT	07-18-23
2	DAMROTH COMMENTS	08-08-23
3	KEYED BEAMS	09-27-23
4		

FOUNDATION PLAN

TF2 of 12

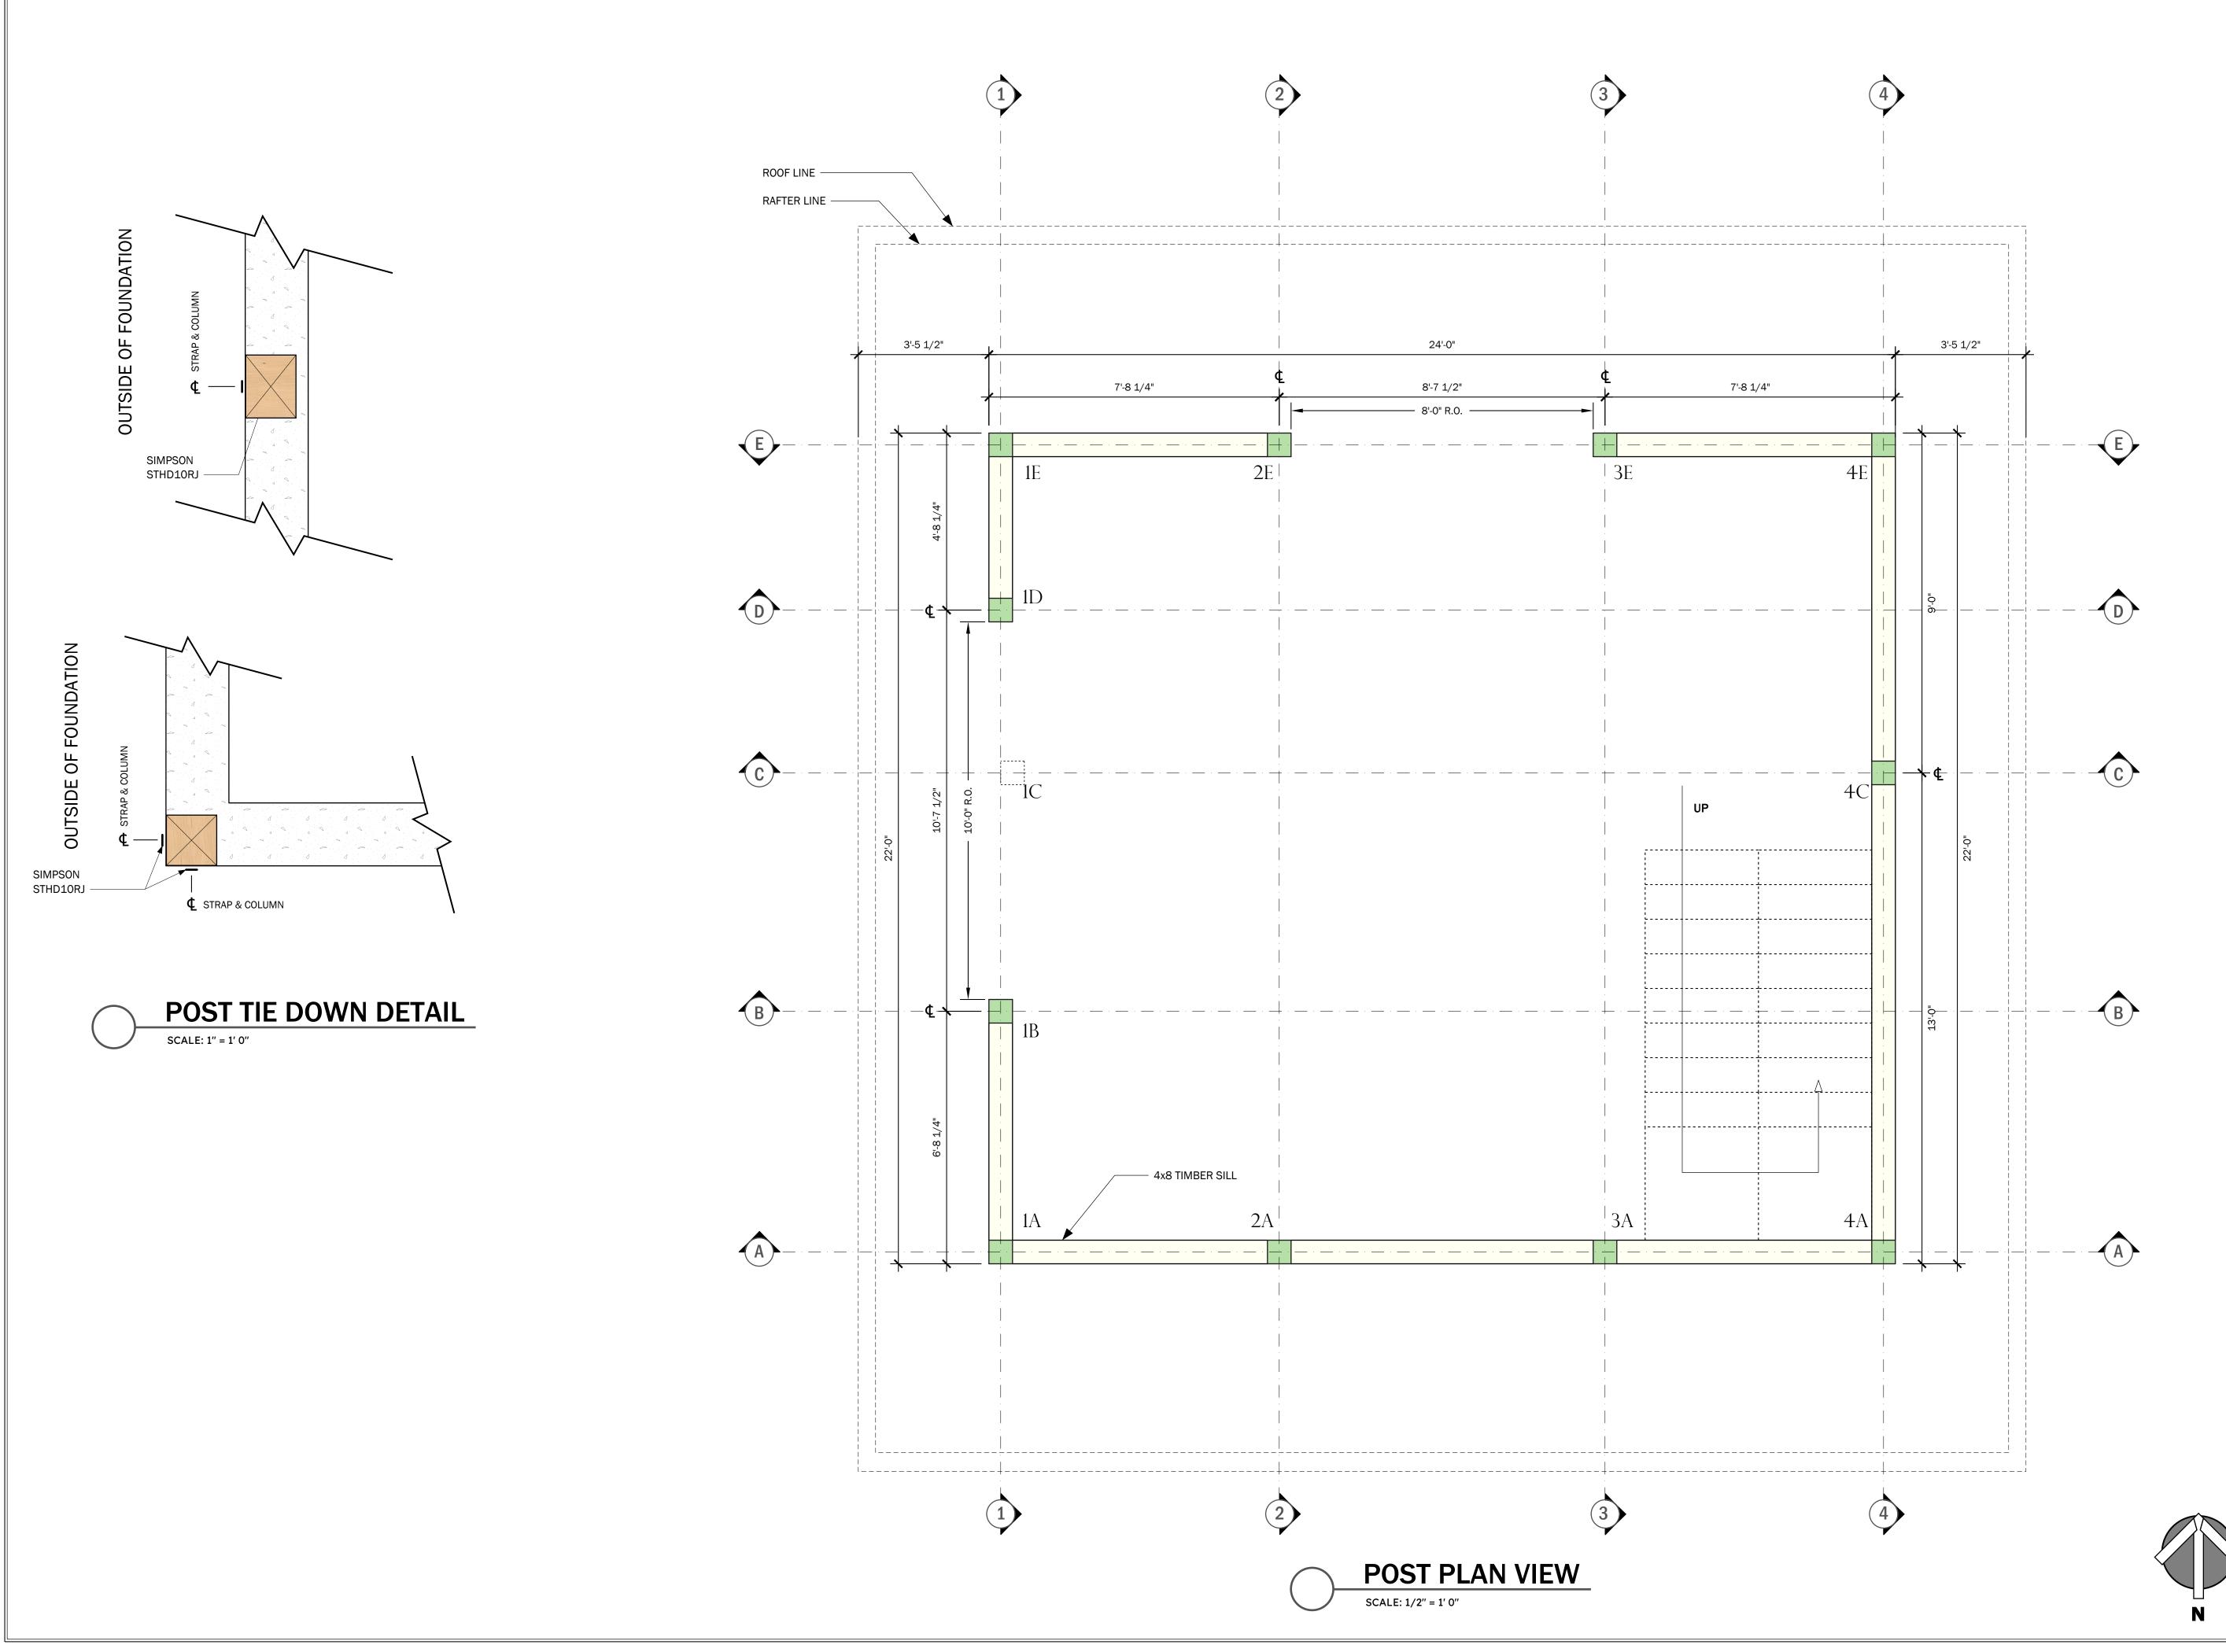



P.O. BOX 225
HARDWICK, MA 01037
PH: (413) 477-6430
Fax: (413) 477-0937
LIC. NO. 010089
WWW.HARDWICKPOSTANDBEAM.COM

PROPOSED PROJECT:

LEE GARAGE

CLIENT:

LEE, BARBARA 15 LAKE ROAD CHILMARK, MA

SITE INFO:

DEPINO / LEE CHILMARK / 15 LAKE ROAD

FILE NAME:	HP&B BARBARALEE CDs 06
DATE MODIFIED): 03-20-24
DRAWN BY:	GM
CHECKED BY:	XXX
SCALE:	VARIES


ALL MATERIAL IS #1 OR BETTER.
EASTERN WHITE PINE.

NO.	REVISIONS	DATE
1	CONCEPT	07-18-23
2	DAMROTH COMMENTS	08-08-23
3	KEYED BEAMS	09-27-23
4		

PLANVIEW

PAGE NUME

TF3 of 12

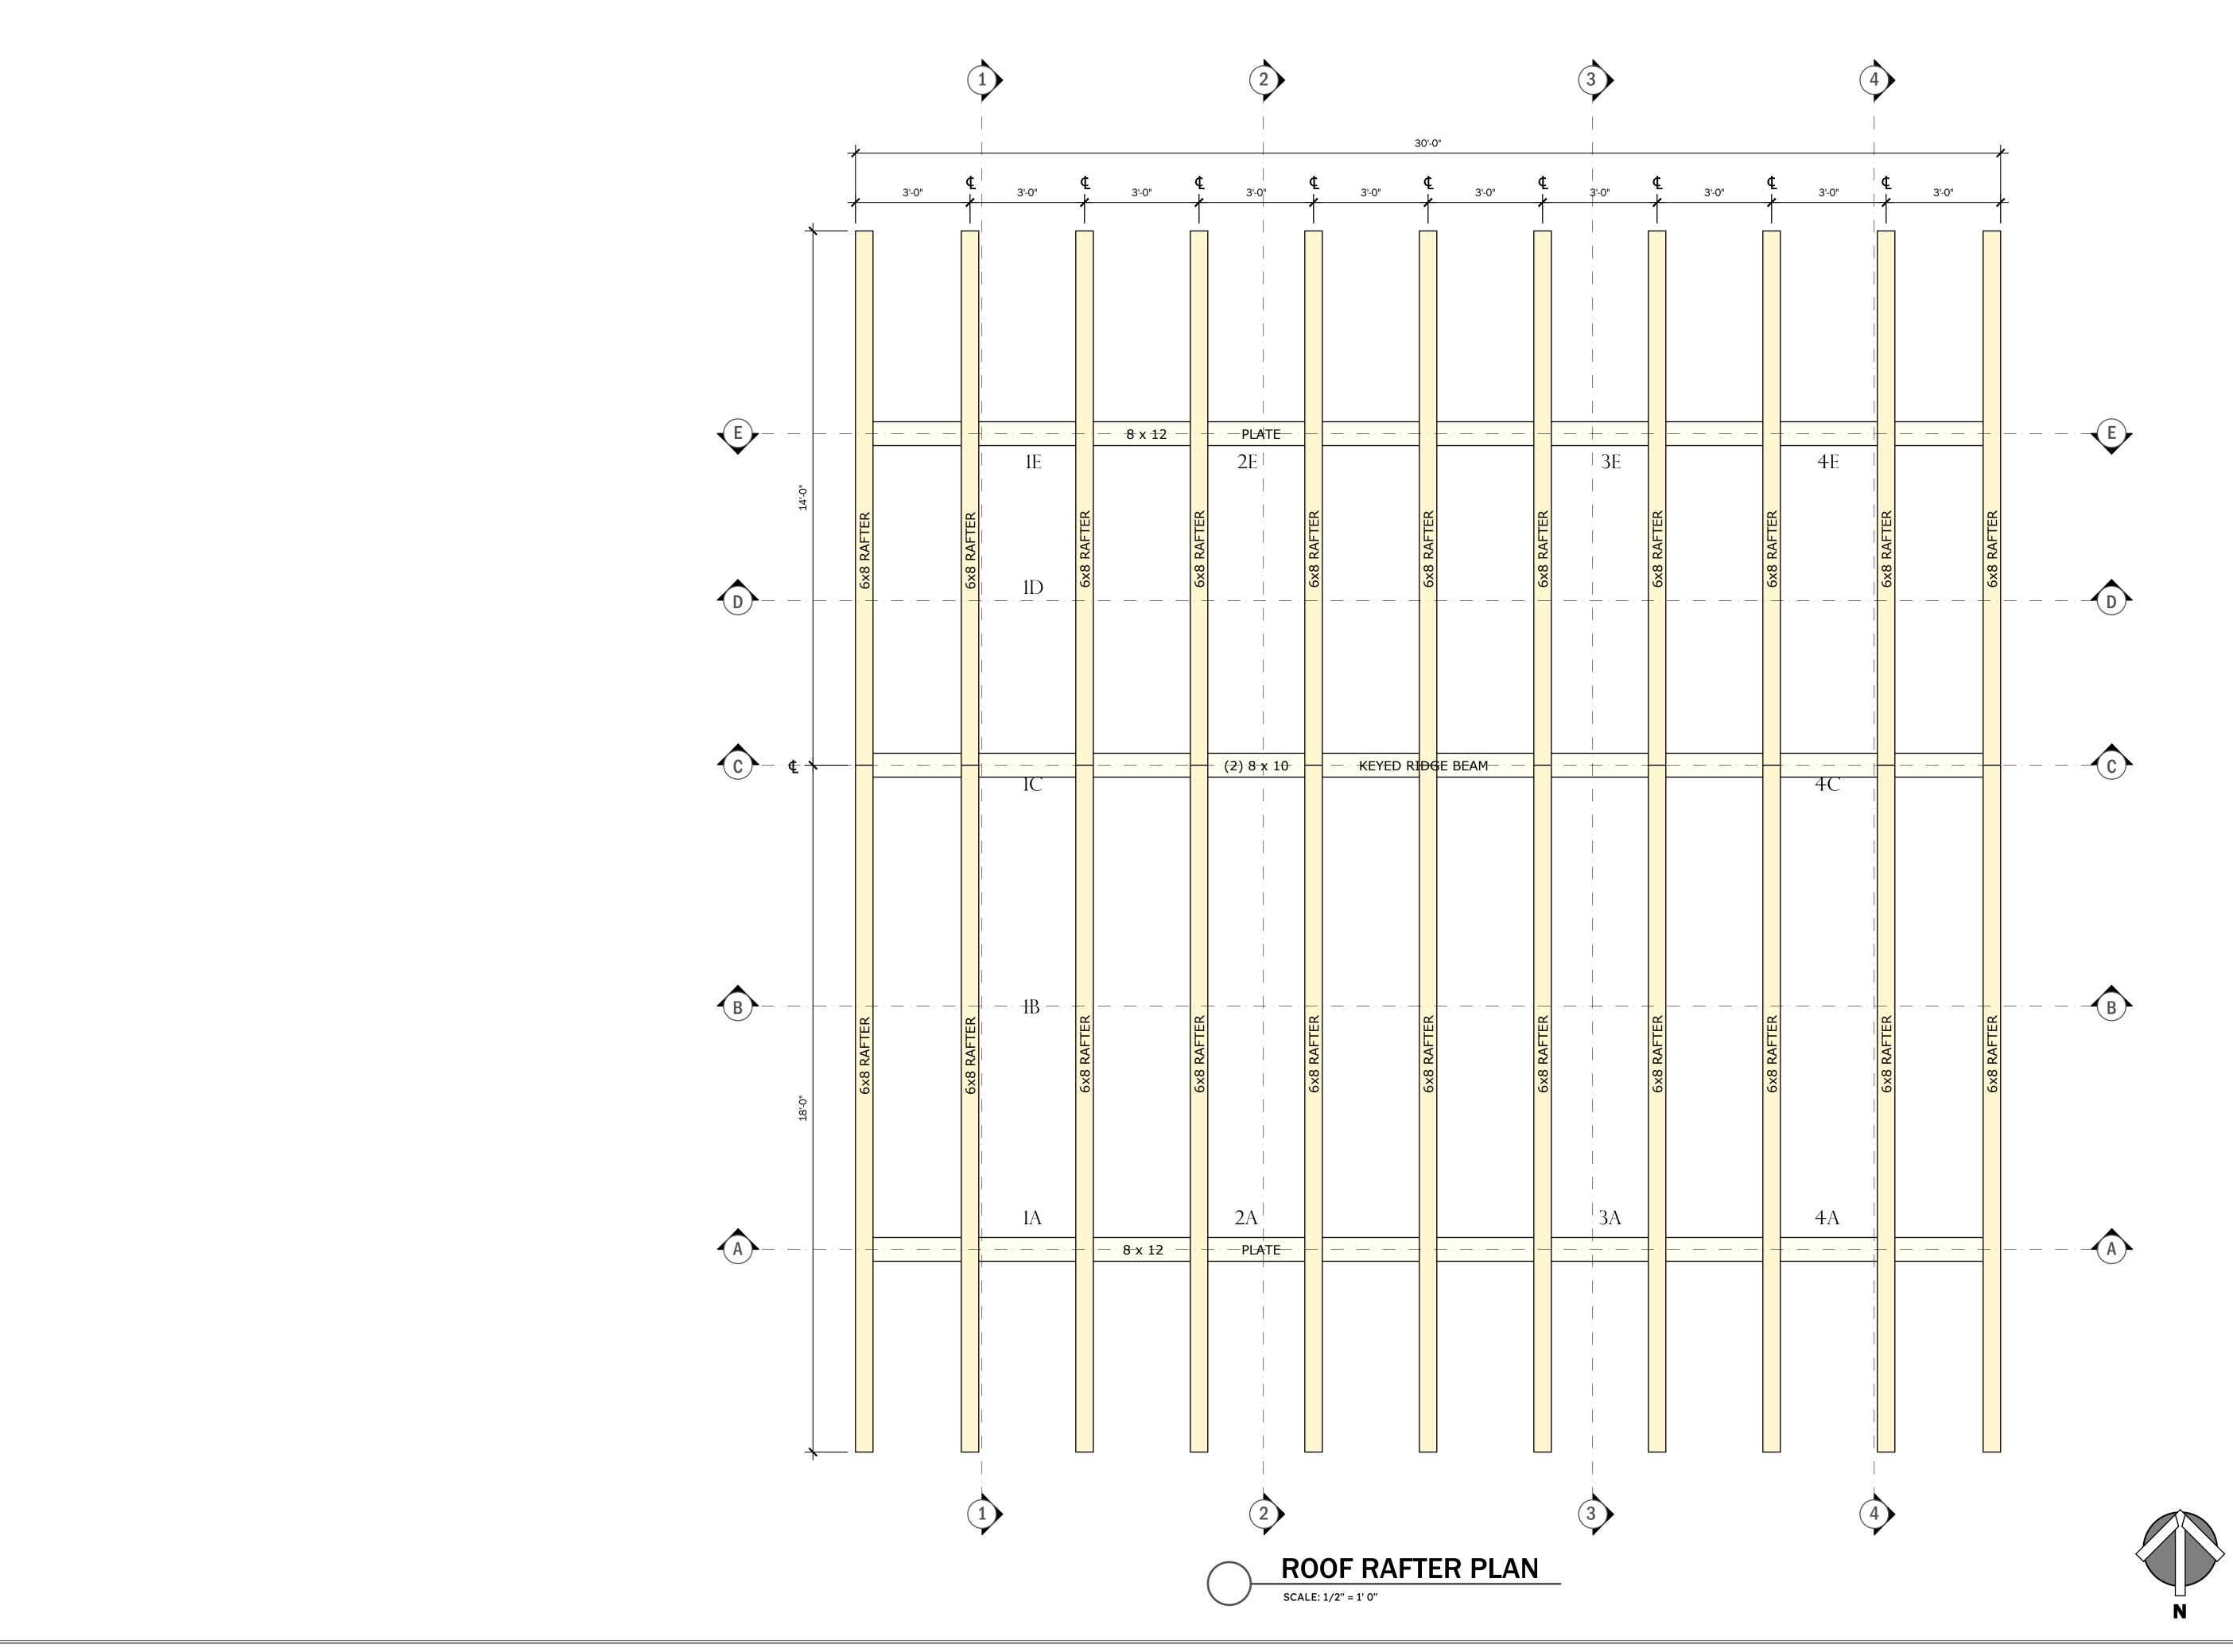



P.O. BOX 225
HARDWICK, MA 01037
Ph: (413) 477-6430
Fax: (413) 477-0937
Lic. No. 010089
WWW.HARDWICKPOSTANDBEAM.COM

PROPOSED PROJECT:

LEE GARAGE

CLIENT:

LEE, BARBARA 15 LAKE ROAD CHILMARK, MA

SITE INFO:

DEPINO / LEE CHILMARK / 15 LAKE ROAD

FILE NAME:	HP&B BARBARALEE_CDs_06
DATE MODIFIED	03-20-24
DRAWN BY:	GM
CHECKED BY:	XXX
SCALE:	VARIES


ALL MATERIAL IS #1 OR BETTER.
EASTERN WHITE PINE.

NO.	REVISIONS	DATE
1	CONCEPT	07-18-23
2	DAMROTH COMMENTS	08-08-23
3	KEYED BEAMS	09-27-23
4		

ROOF PLAN

PAGE NUMB

TF4 of 12

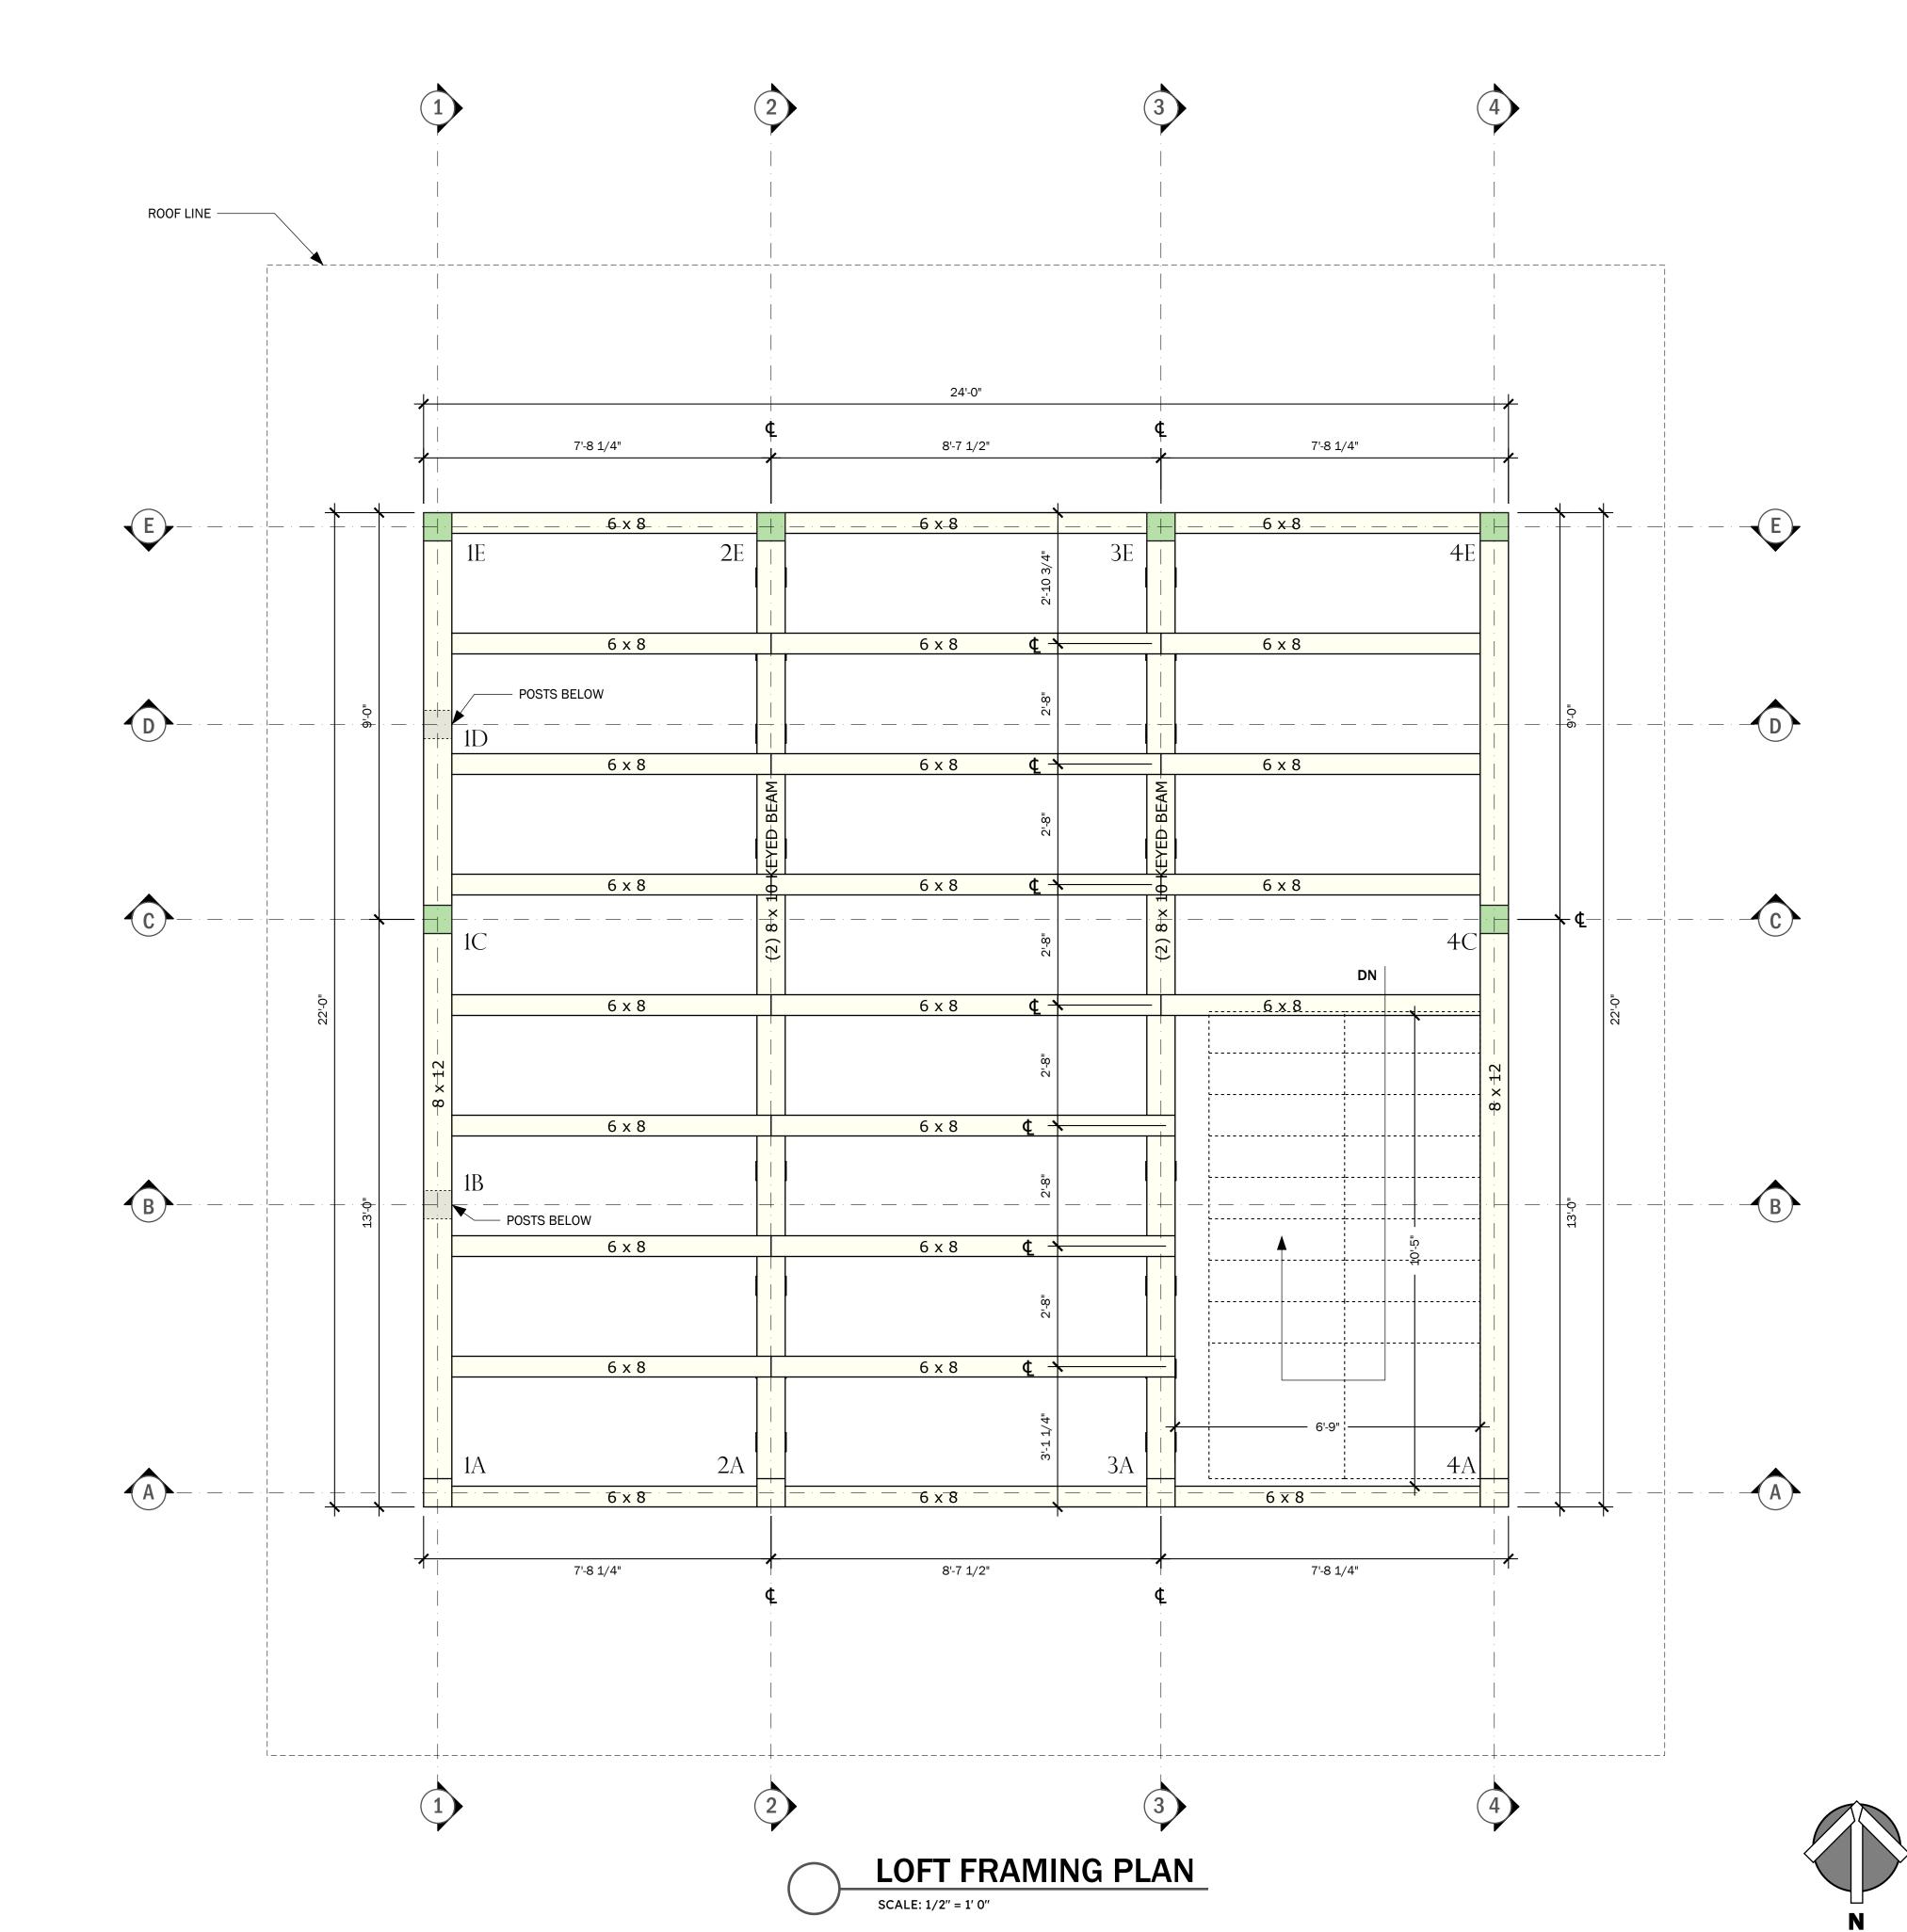



P.O. BOX 225
HARDWICK, MA 01037
Ph: (413) 477-6430
FAX: (413) 477-0937
LIC. NO. 010089
WWW.HARDWICKPOSTANDBEAM.COM

PROPOSED PROJECT:

LEE GARAGE

CLIENT:

LEE, BARBARA 15 LAKE ROAD CHILMARK, MA

SITE INFO:

DEPINO / LEE CHILMARK / 15 LAKE ROAD

FILE NAME:	HP&B BARBARALEE_CDS_06
DATE MODIFIED	03-20-24
DRAWN BY:	GM
CHECKED BY:	XXX
SCALE:	VARIES


ALL MATERIAL IS #1 OR BETTER. EASTERN WHITE PINE.

NO.	REVISIONS	DATE
1	CONCEPT	07-18-23
2	DAMROTH COMMENTS	08-08-23
3	KEYED BEAMS	09-27-23
4		

LOFT FRAMING PLAN

PAGE NUME

TF5 of 12

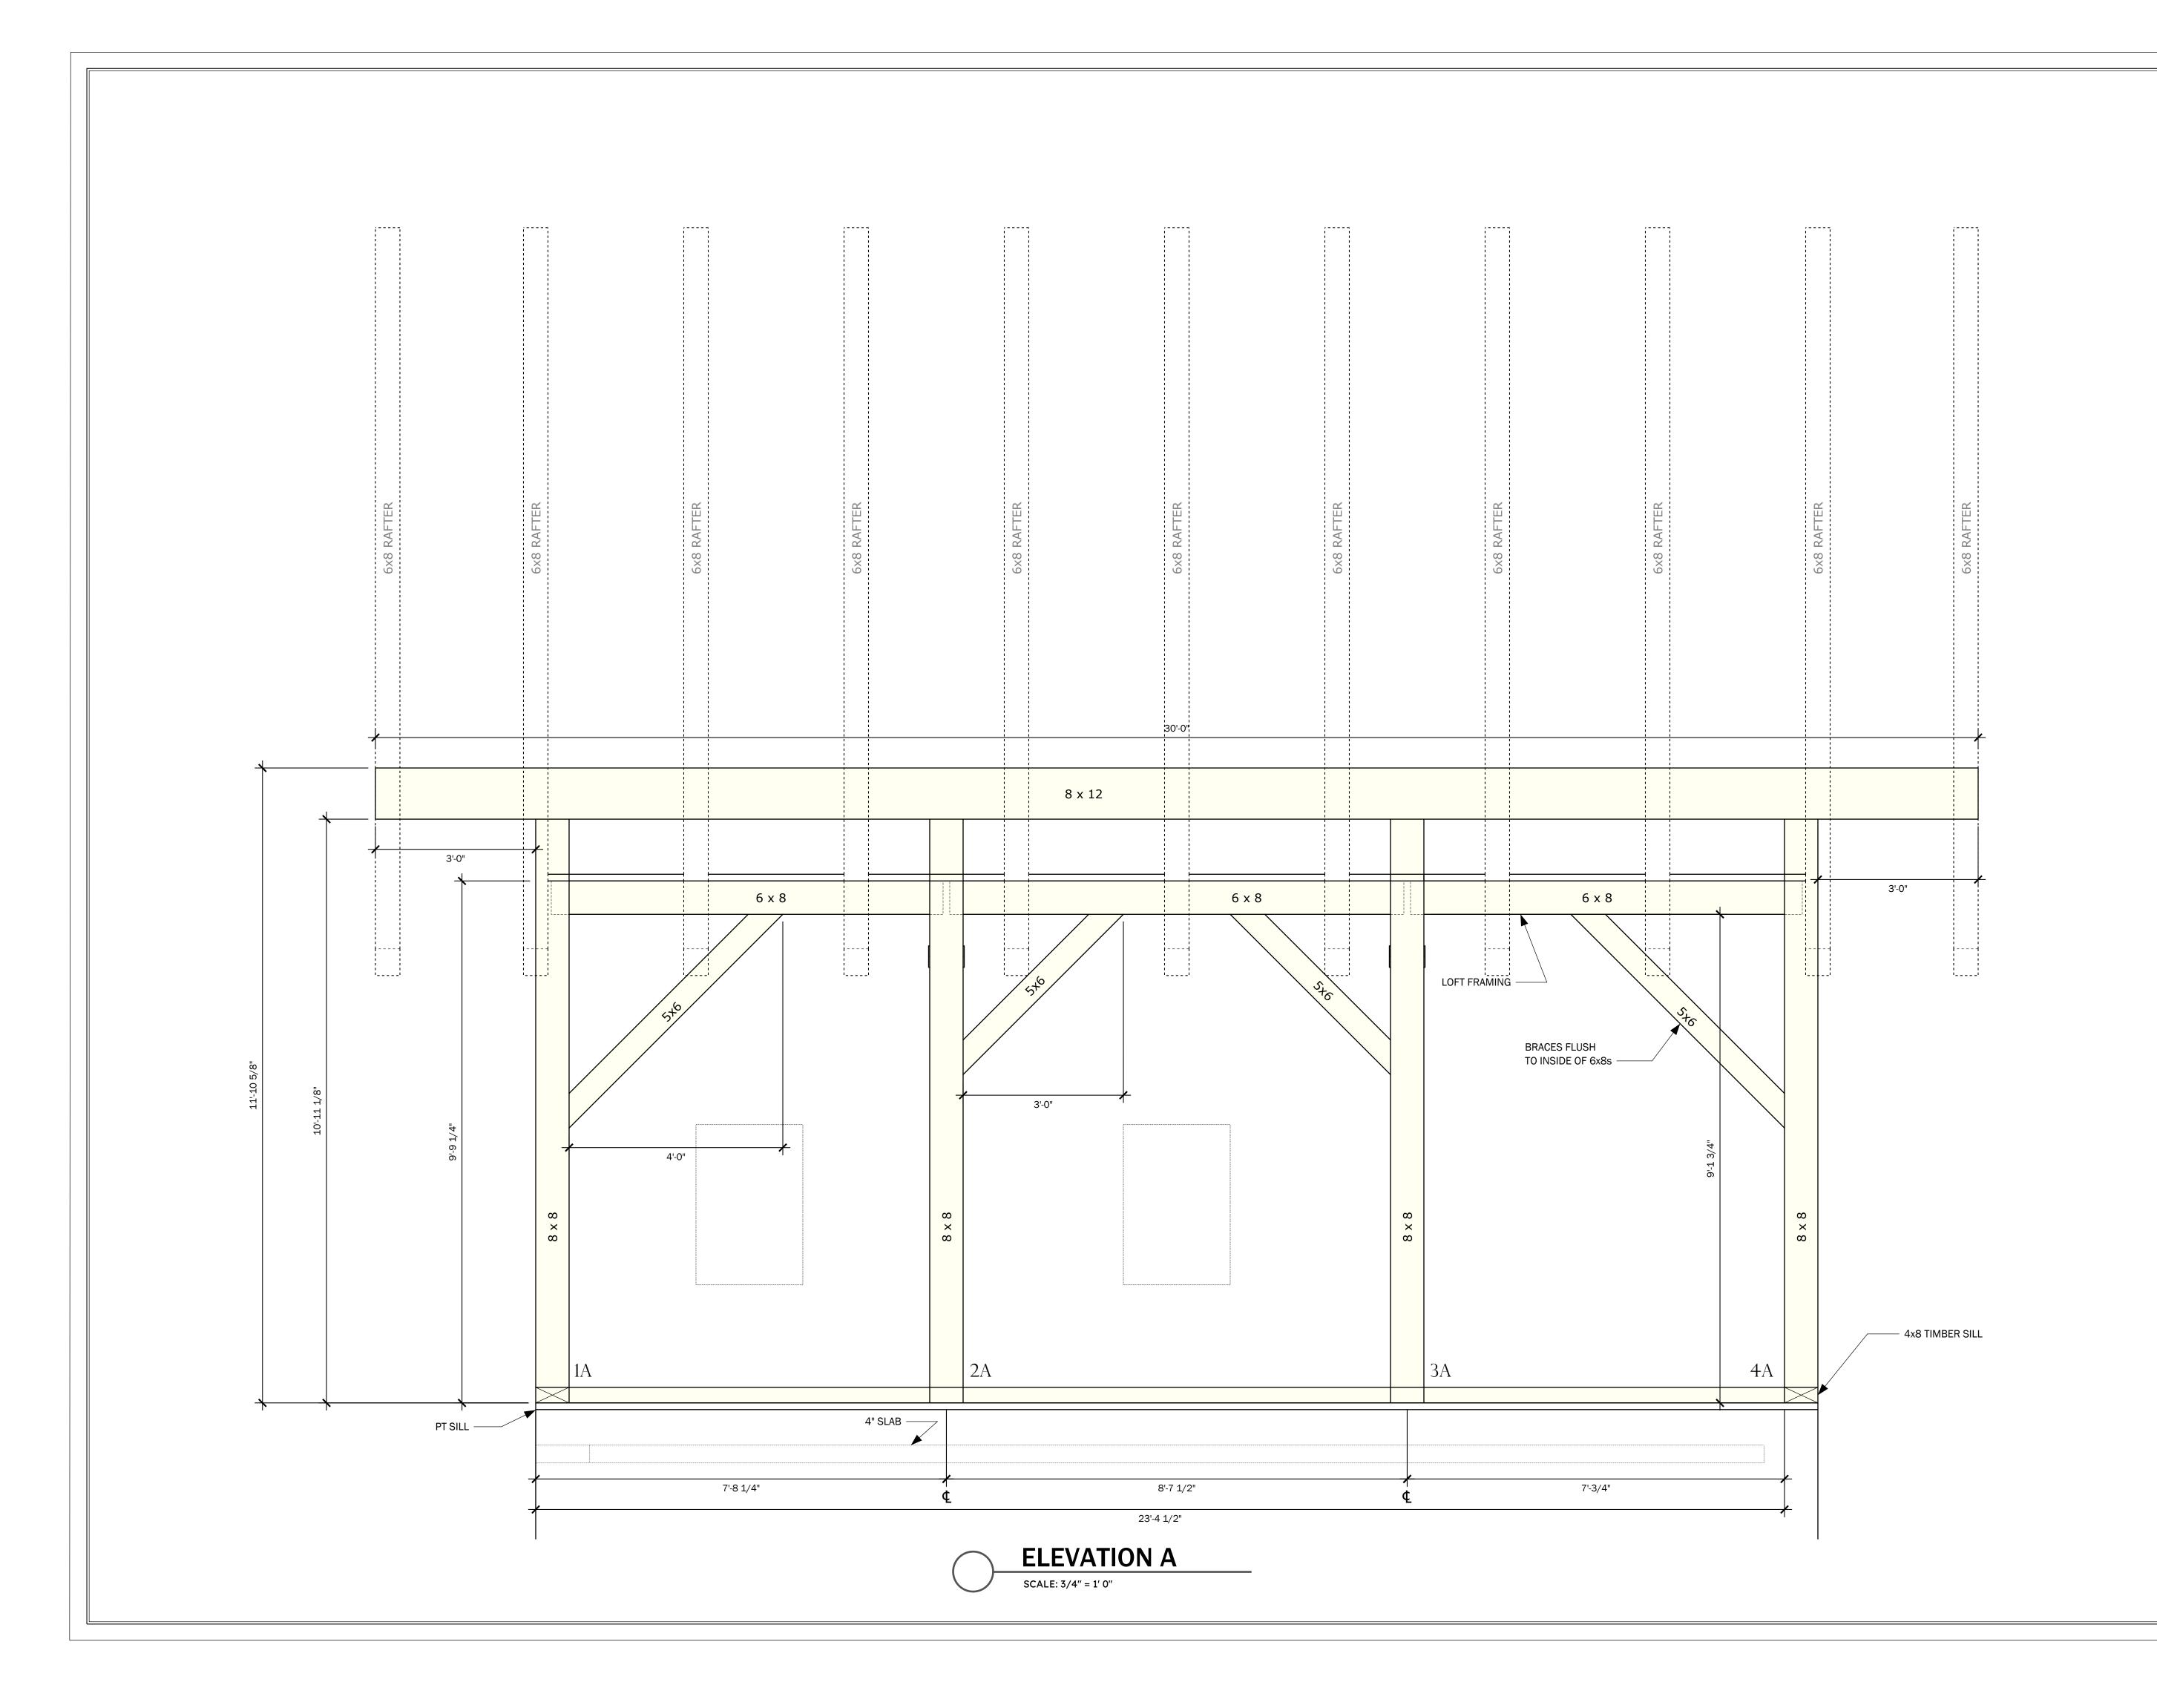



P.O. BOX 225
HARDWICK, MA 01037
PH: (413) 477-6430
FAX: (413) 477-0937
LIC. NO. 010089
WWW.HARDWICKPOSTANDBEAM.COM

PROPOSED PROJECT:

LEE GARAGE

CLIENT:

LEE, BARBARA 15 LAKE ROAD CHILMARK, MA

SITE INFO:

DEPINO / LEE CHILMARK / 15 LAKE ROAD

FILE N	AME: HP&B	HP&B BarbaraLee_CDs_06	
DATE	MODIFIED:	03-20-24	
DRAW	N BY:	GM	
CHECK	KED BY:	XXX	
SCALE	·•	VARIES	


ALL MATERIAL IS #1 OR BETTER. EASTERN WHITE PINE.


NO.	REVISIONS	DATE
1	CONCEPT	07-18-23
2	DAMROTH COMMENTS	08-08-23
3	KEYED BEAMS	09-27-23
4		

ELEVATION A

PAGE NUMBER

TF6 of 12

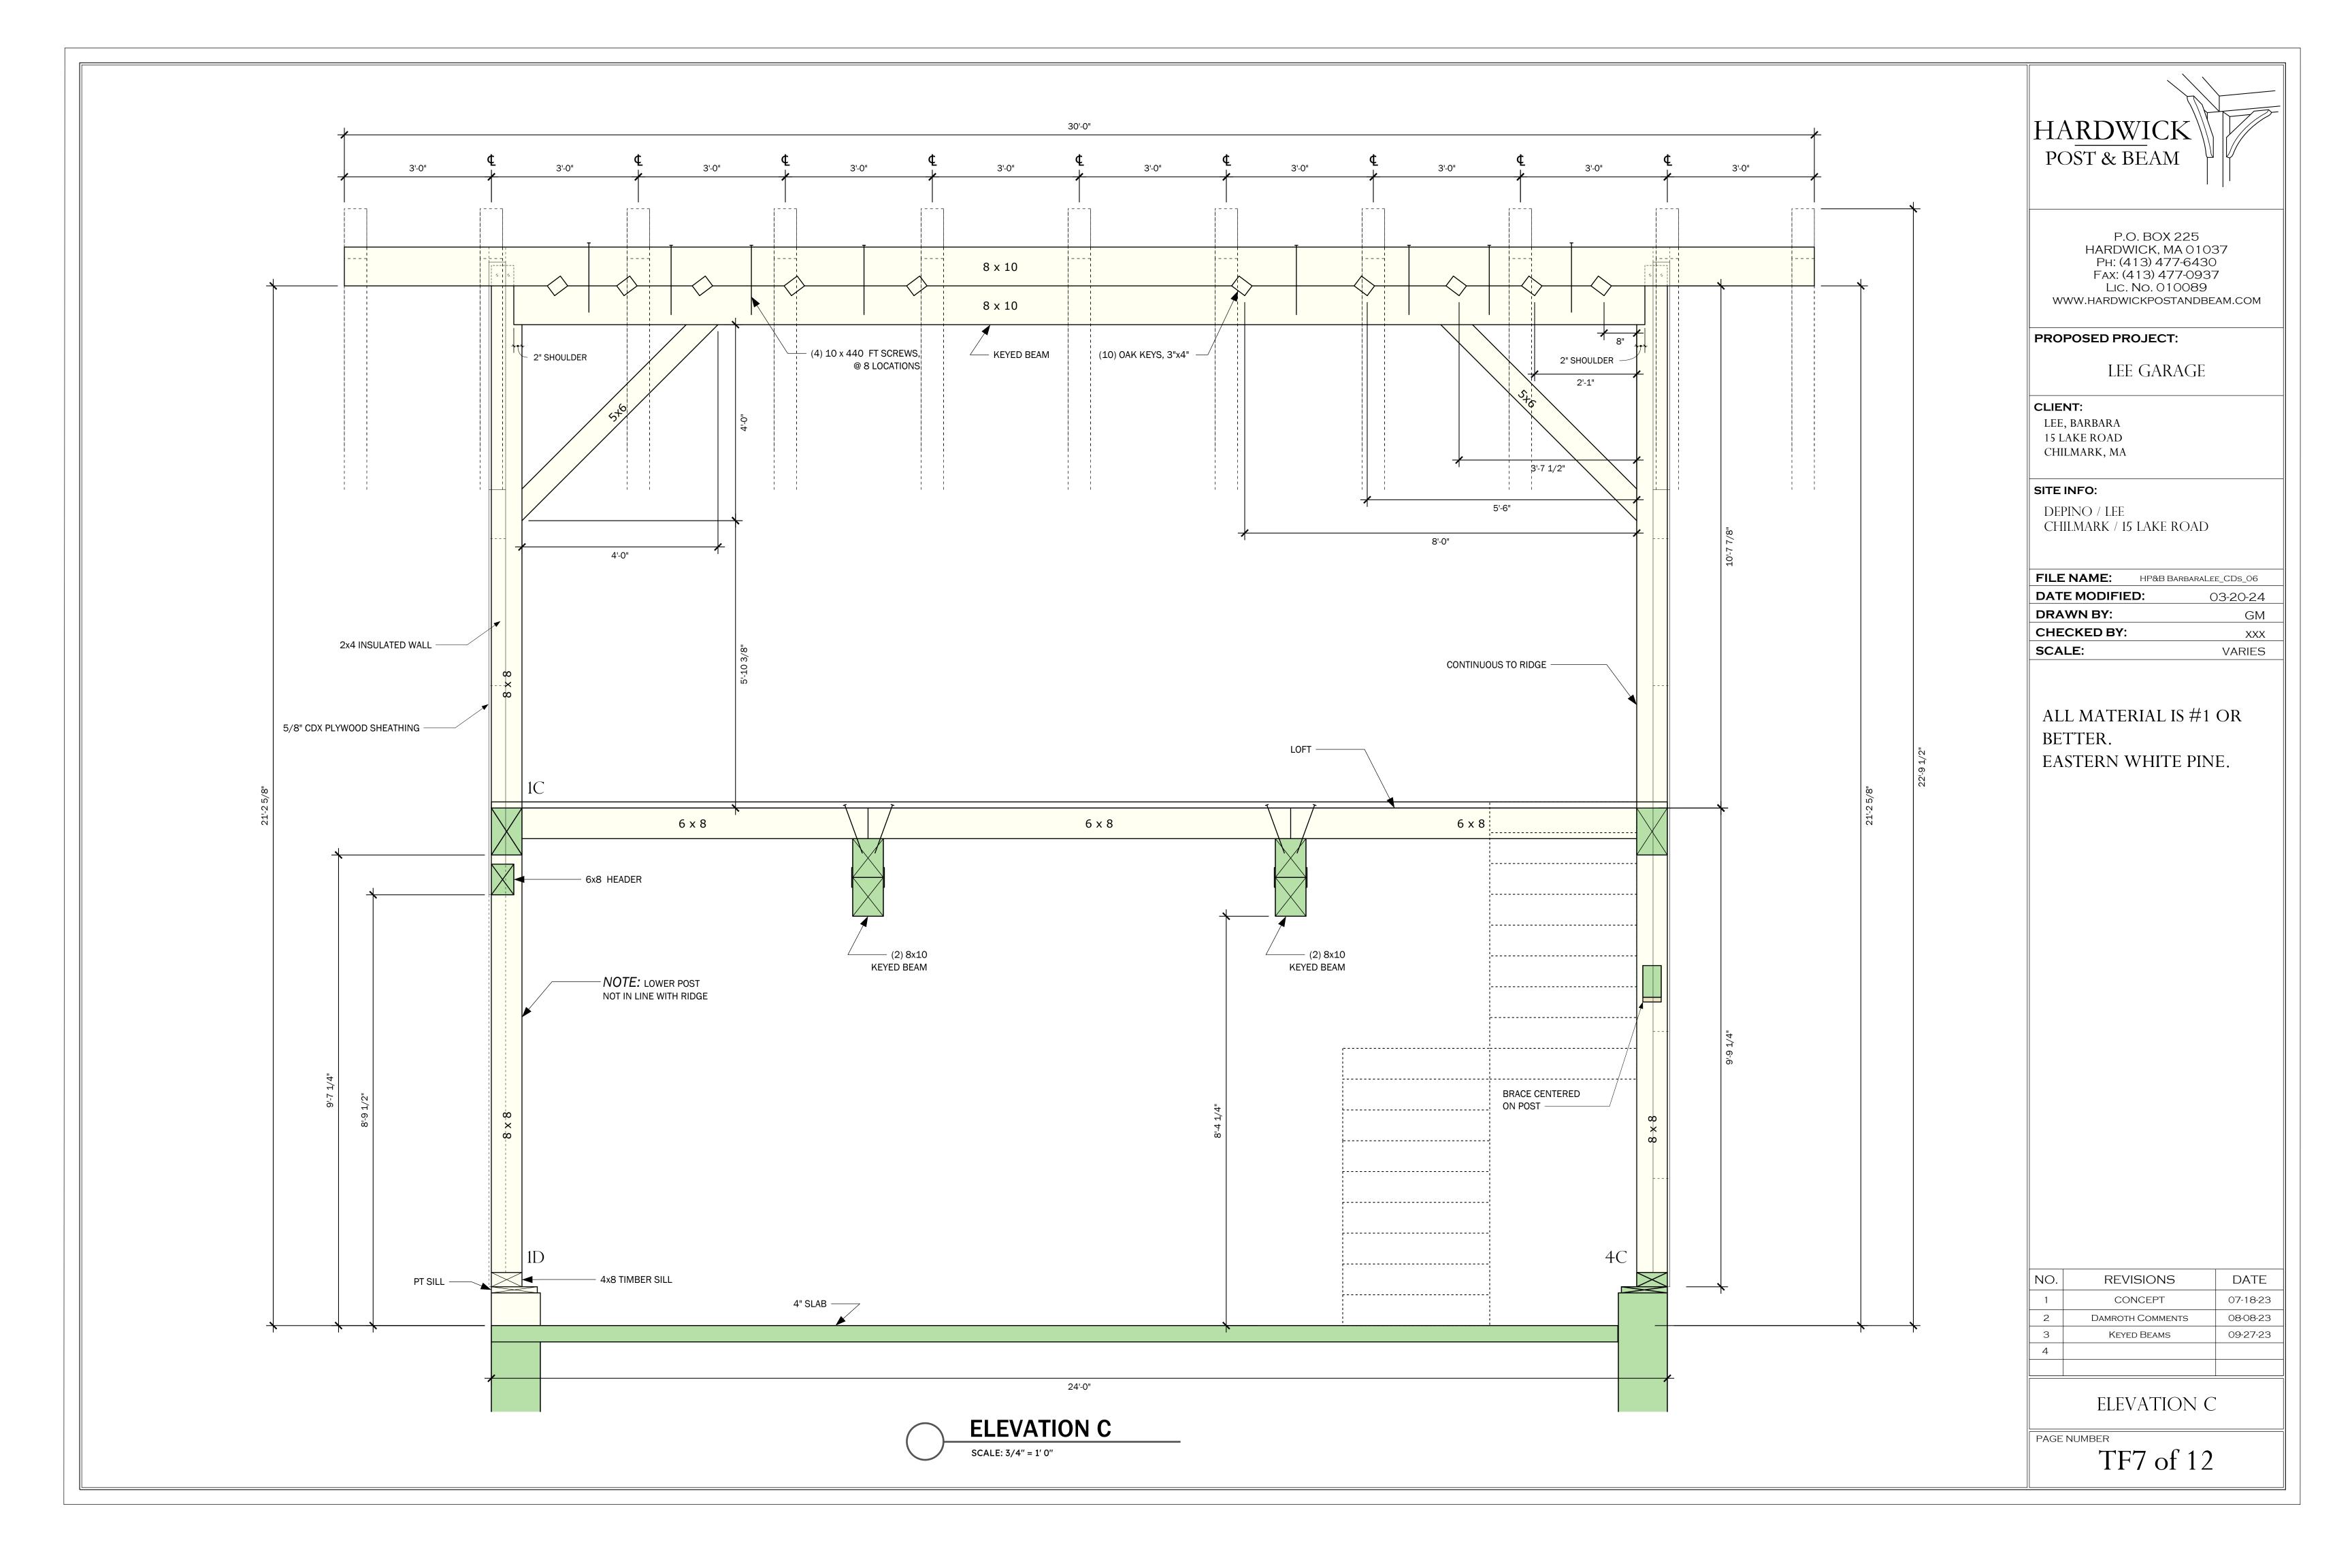

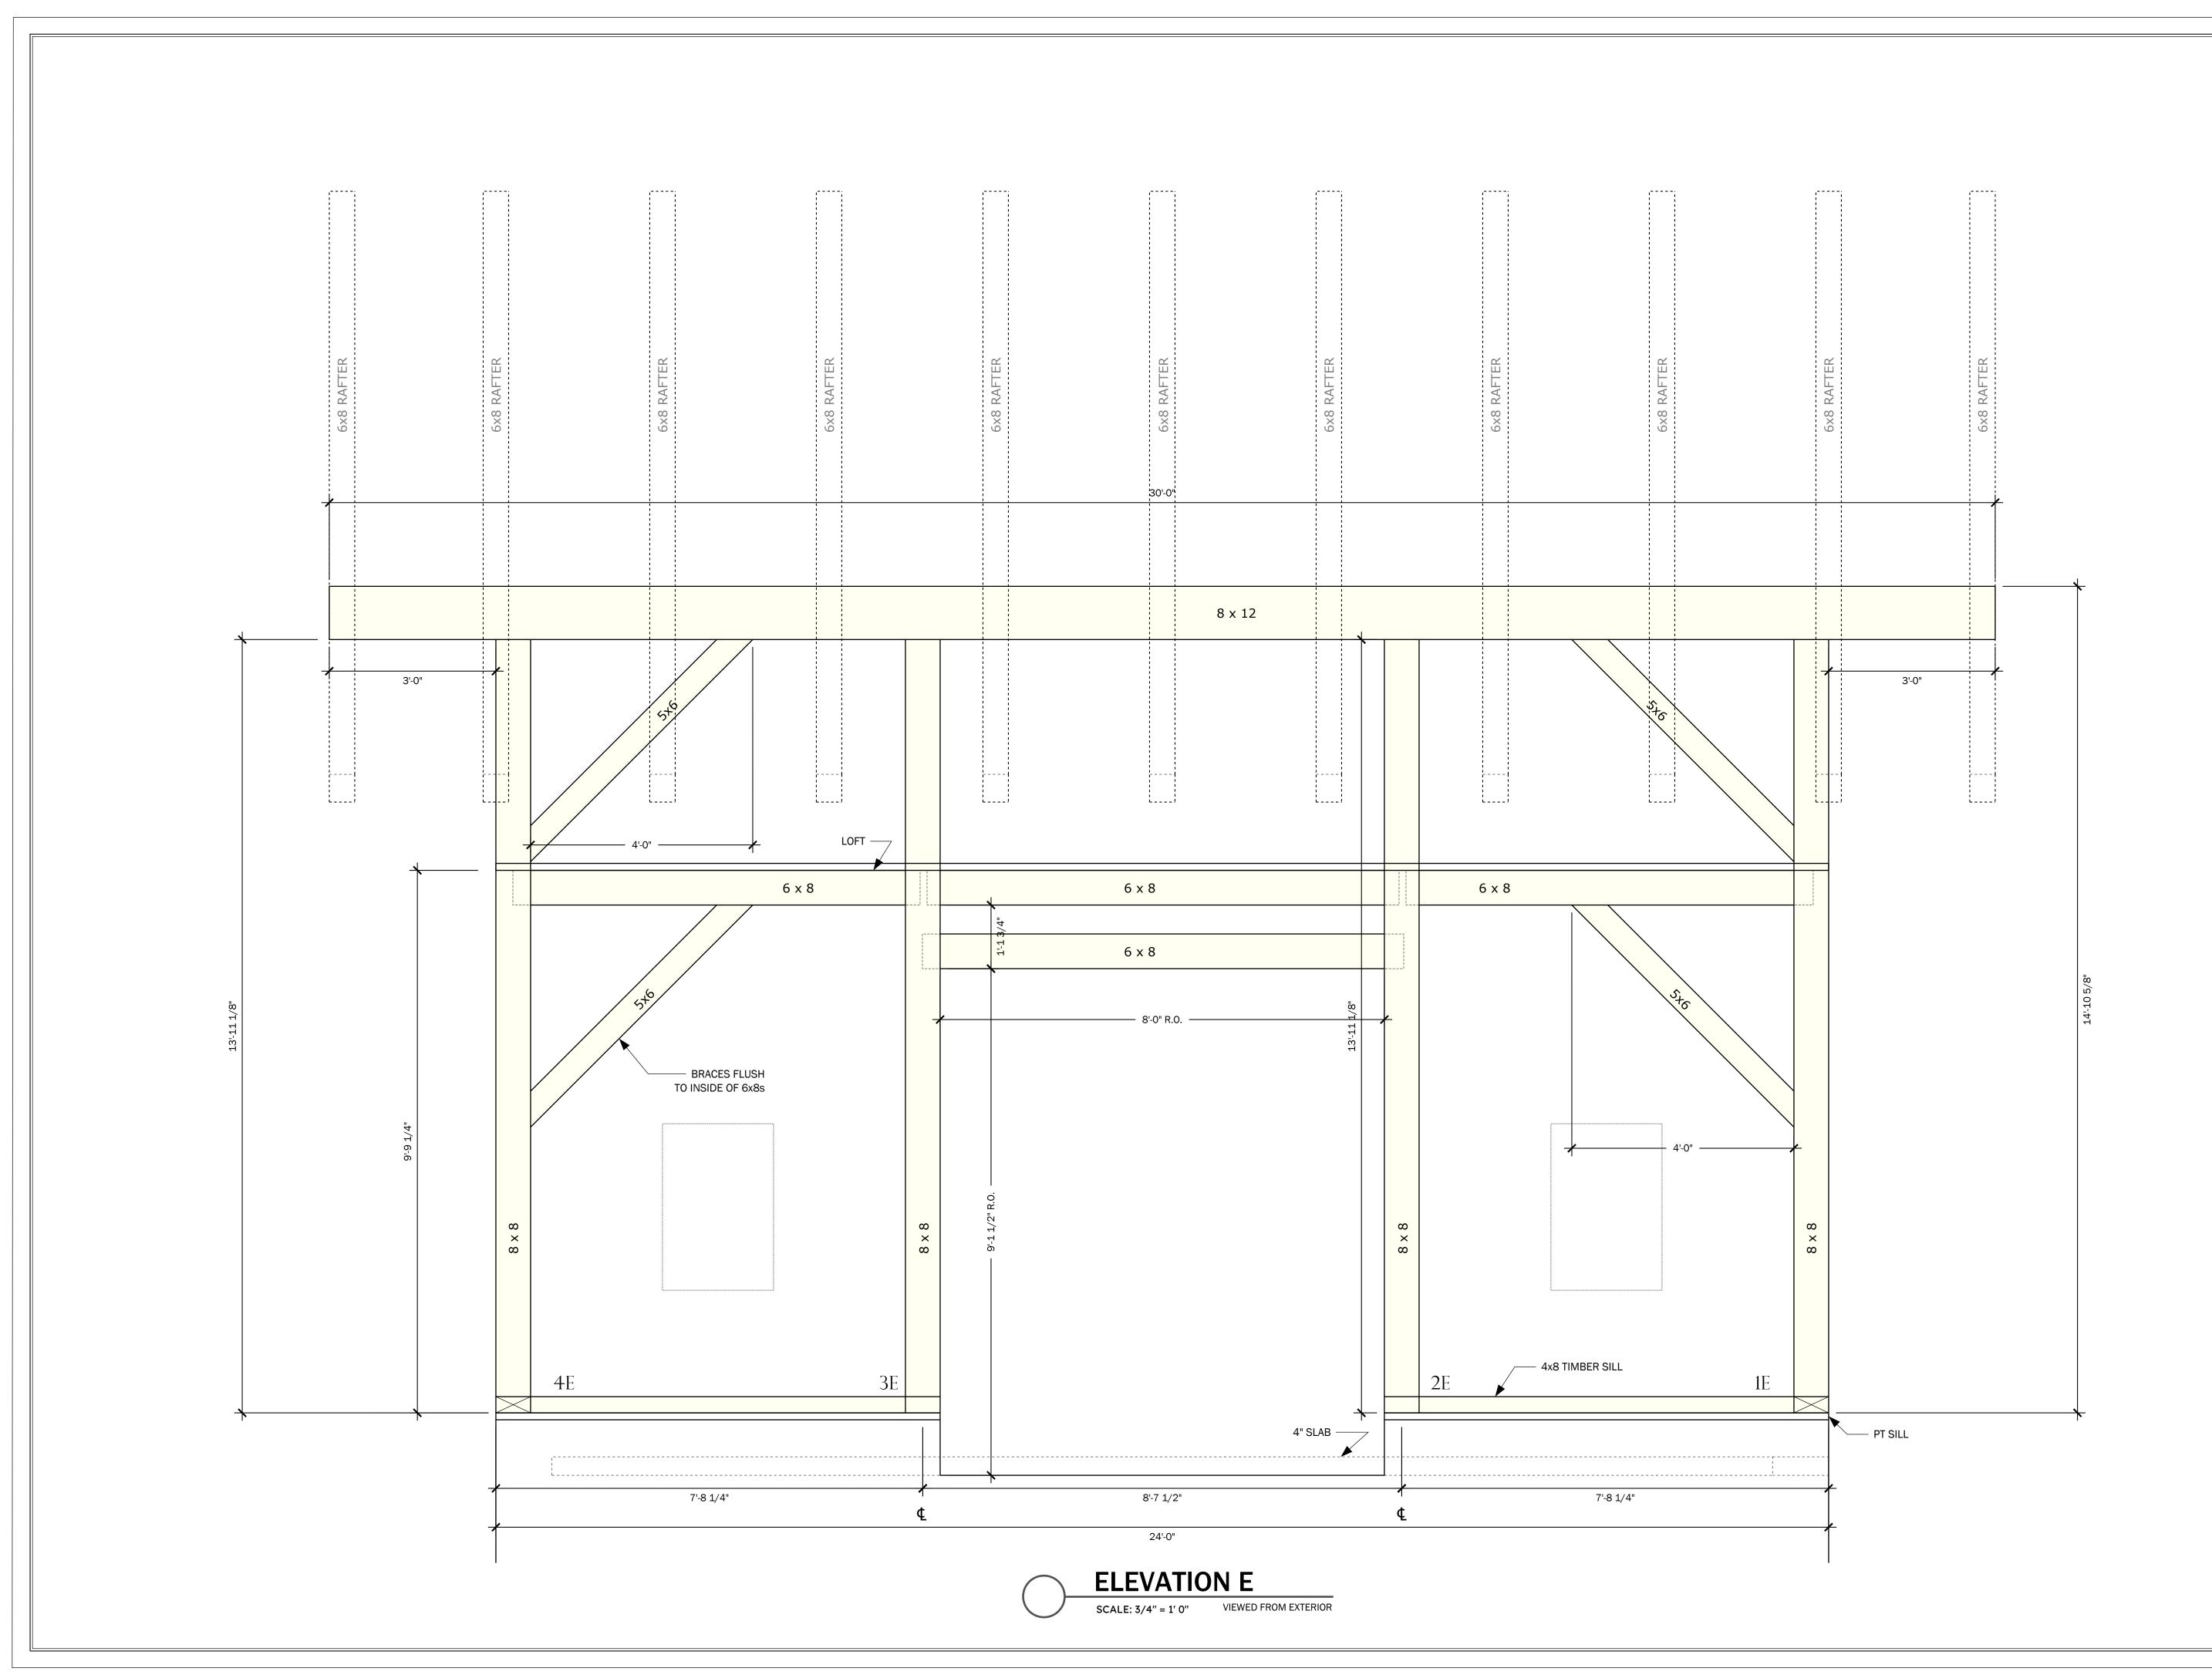



P.O. BOX 225
HARDWICK, MA 01037
PH: (413) 477-6430
FAX: (413) 477-0937
LIC. NO. 010089
WWW.HARDWICKPOSTANDBEAM.COM

PROPOSED PROJECT:

LEE GARAGE

CLIENT:

LEE, BARBARA 15 LAKE ROAD CHILMARK, MA

SITE INFO:

DEPINO / LEE CHILMARK / 15 LAKE ROAD

FILE NAME:	HP&B BARBARALEE_CDS_06
DATE MODIFIED) : 03-20-24
DRAWN BY:	GM
CHECKED BY:	XXX
SCALE:	VARIES


ALL MATERIAL IS #1 OR BETTER. EASTERN WHITE PINE.


NO.	REVISIONS	DATE
1	CONCEPT	07-18-23
2	DAMROTH COMMENTS	08-08-23
3	KEYED BEAMS	09-27-23
4		


ELEVATION E

PAGE NUMBER

TF8 of 12

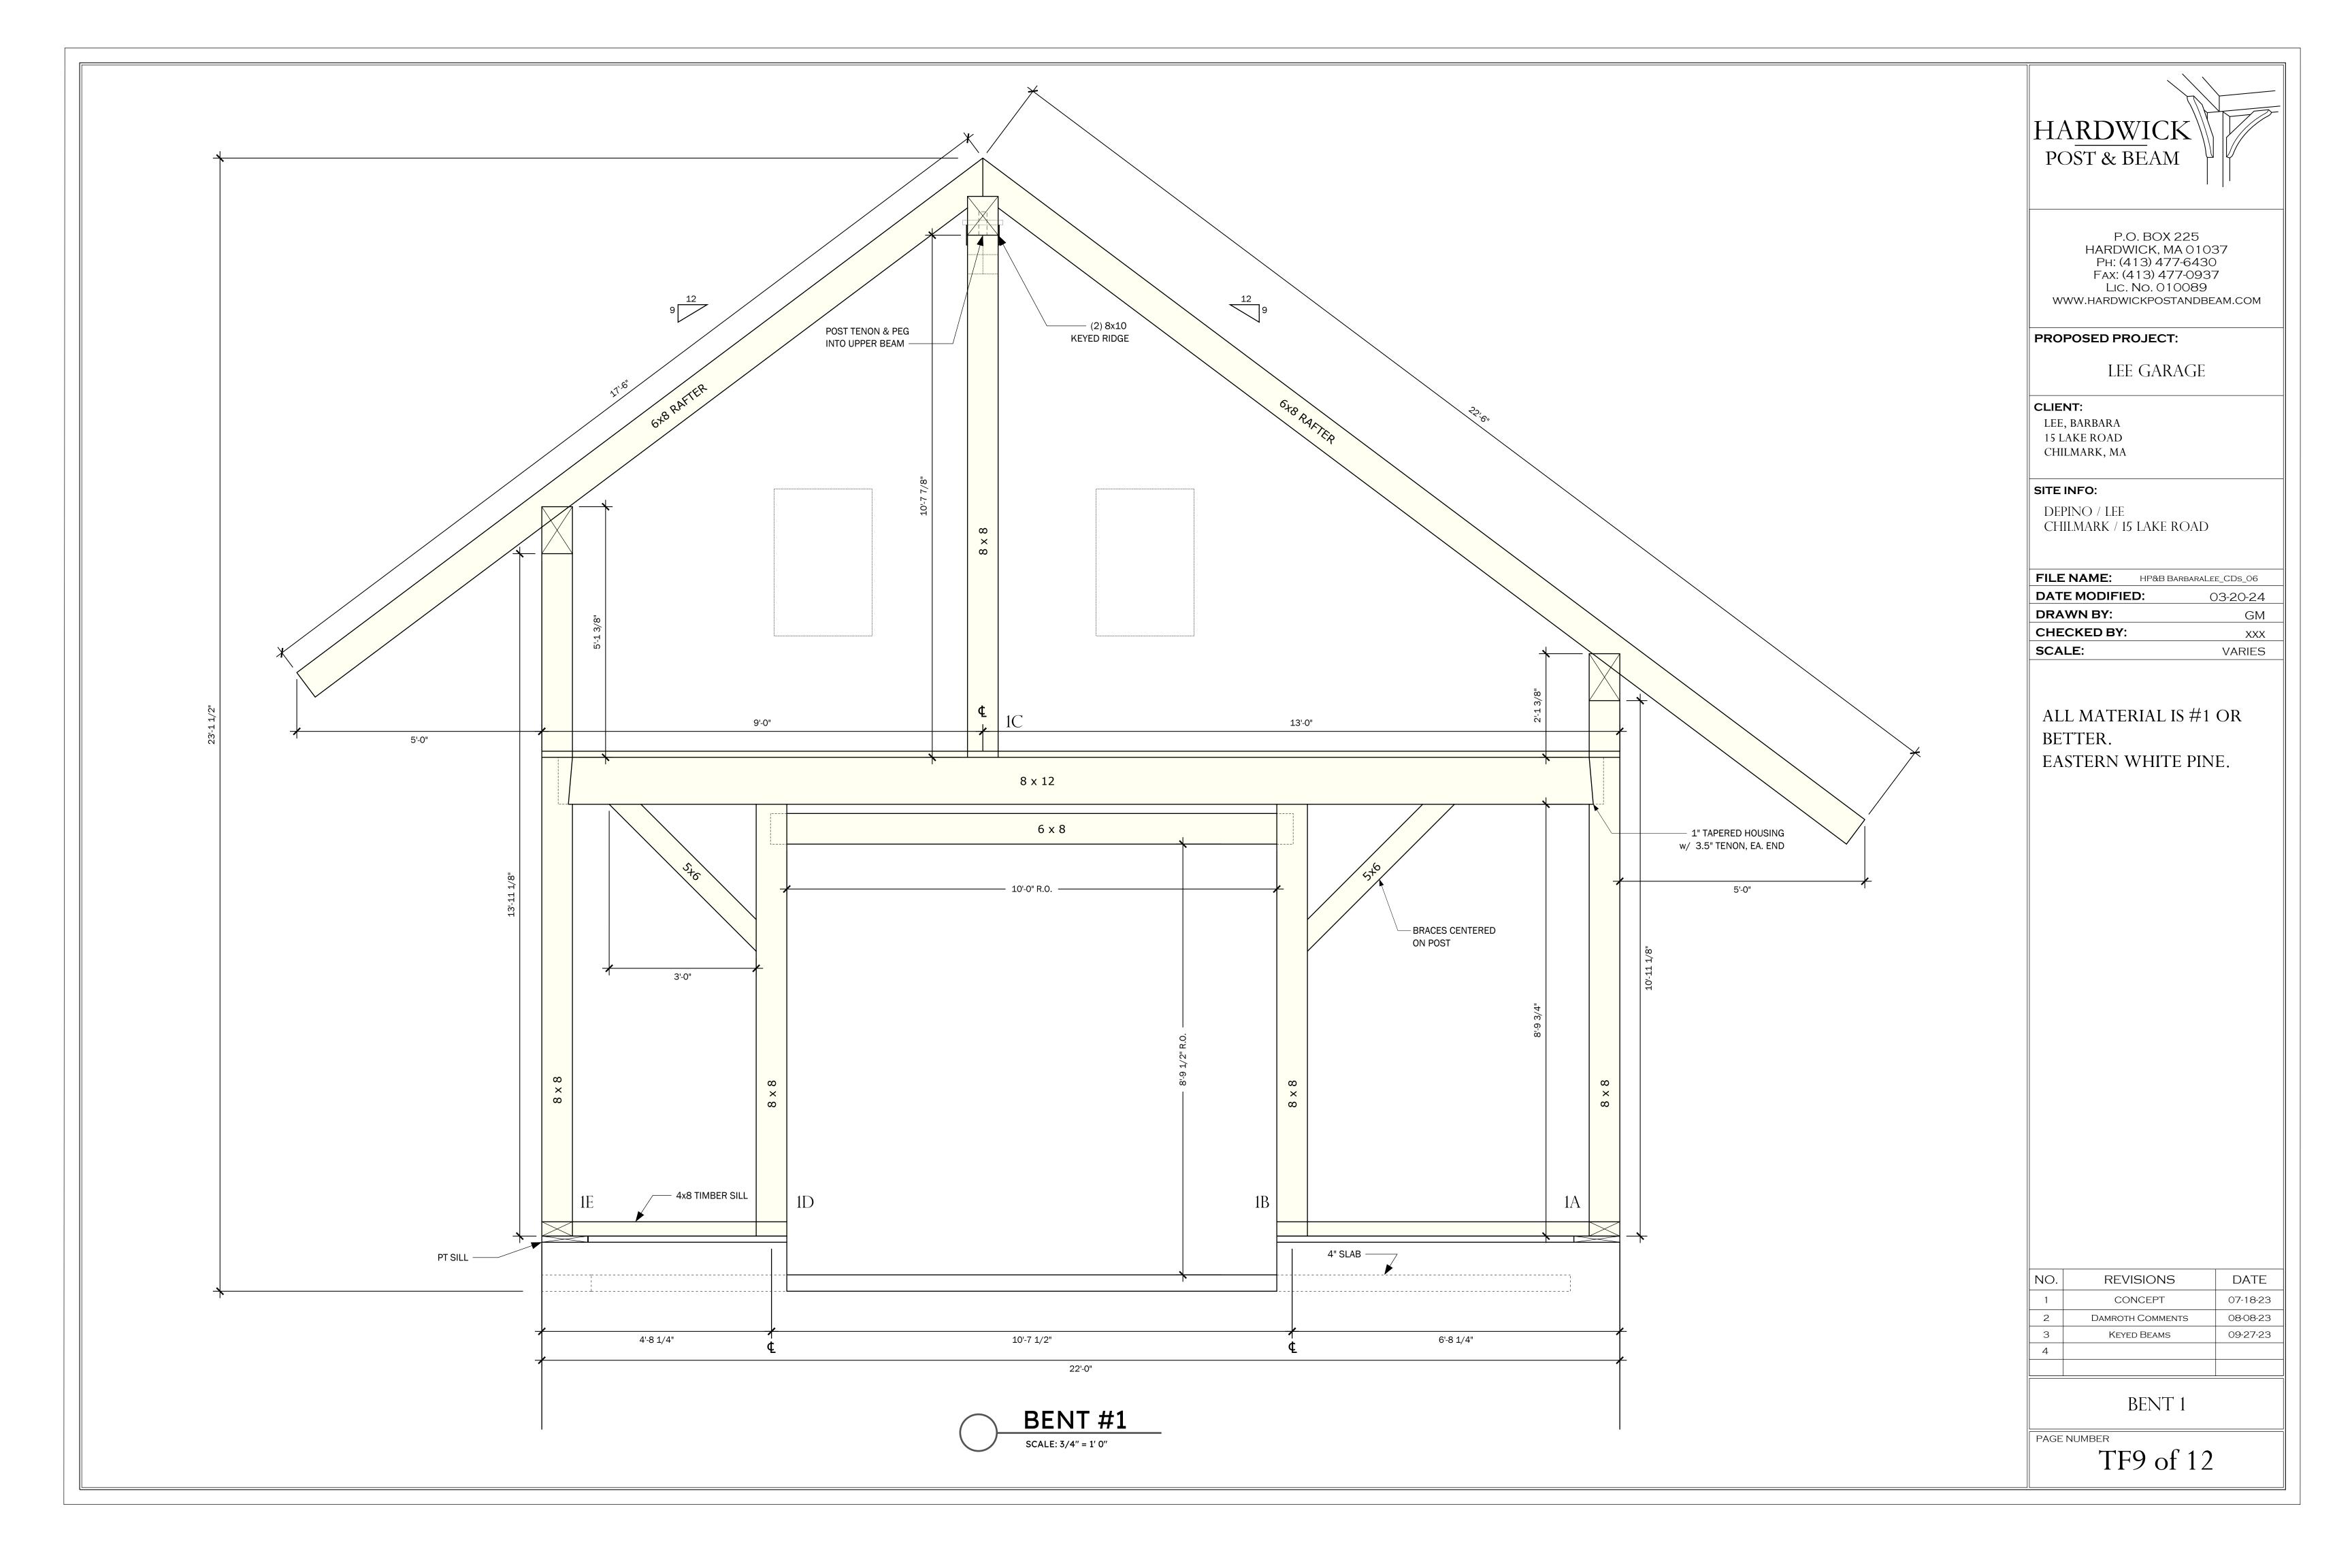

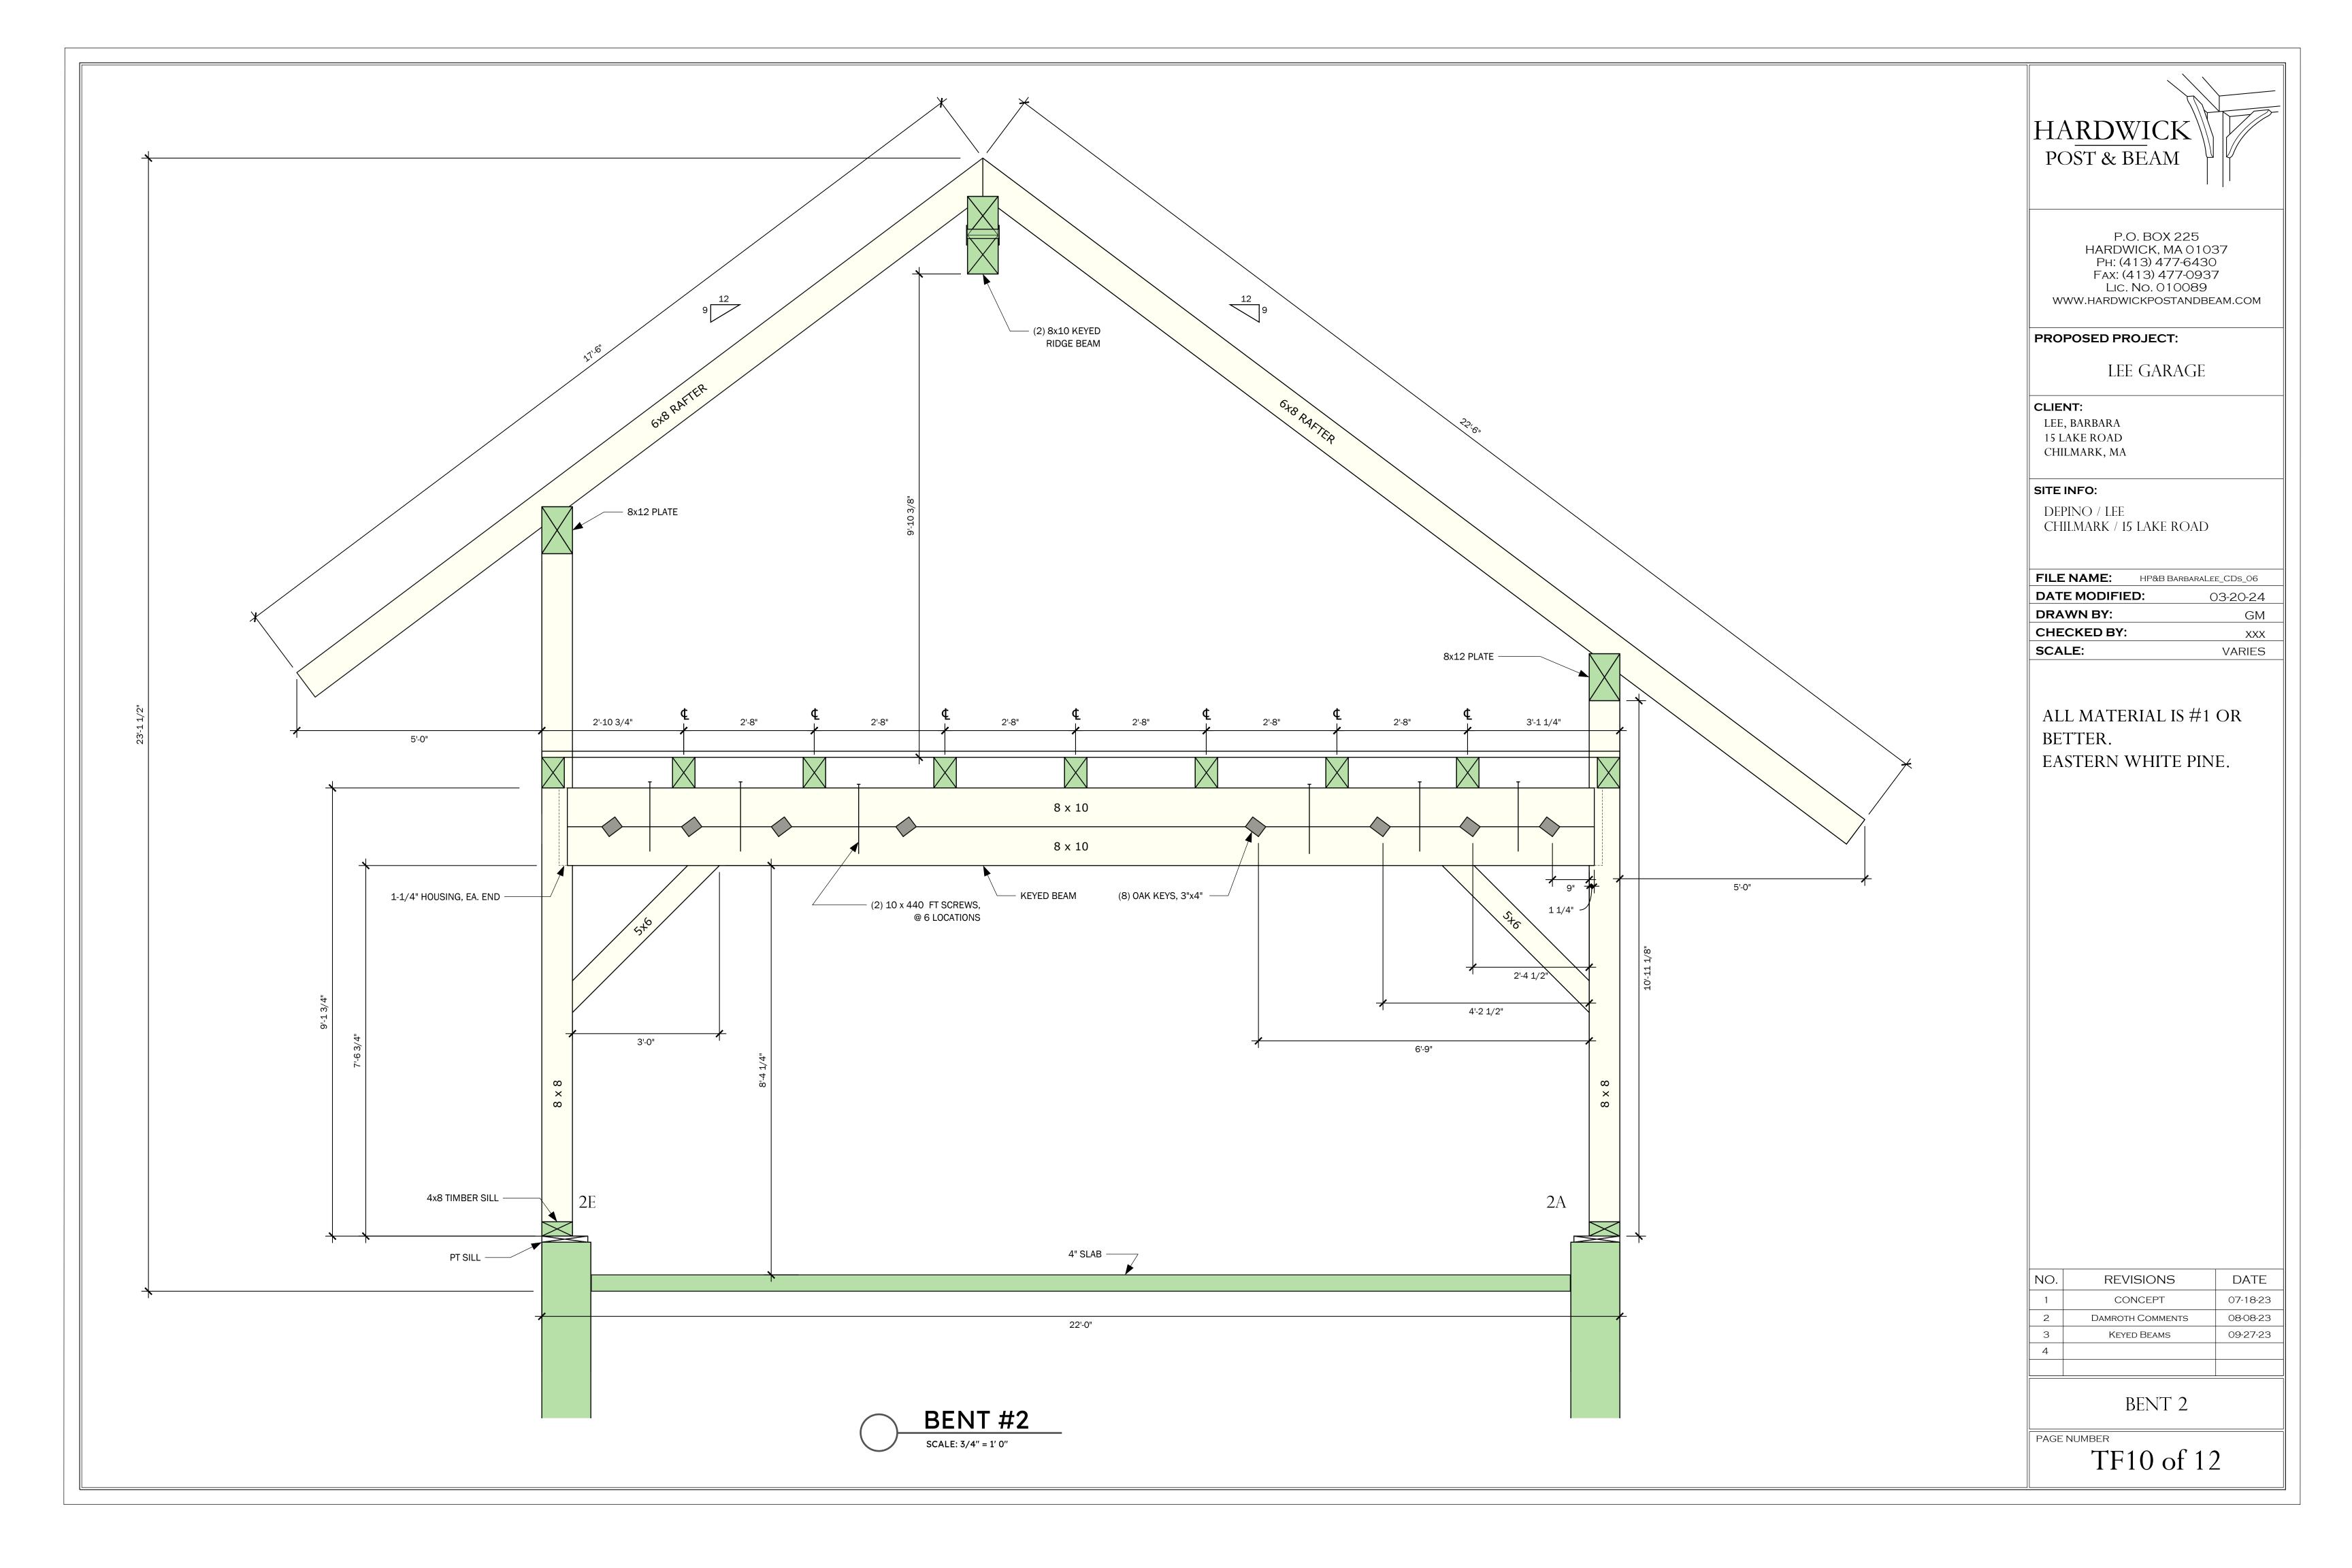

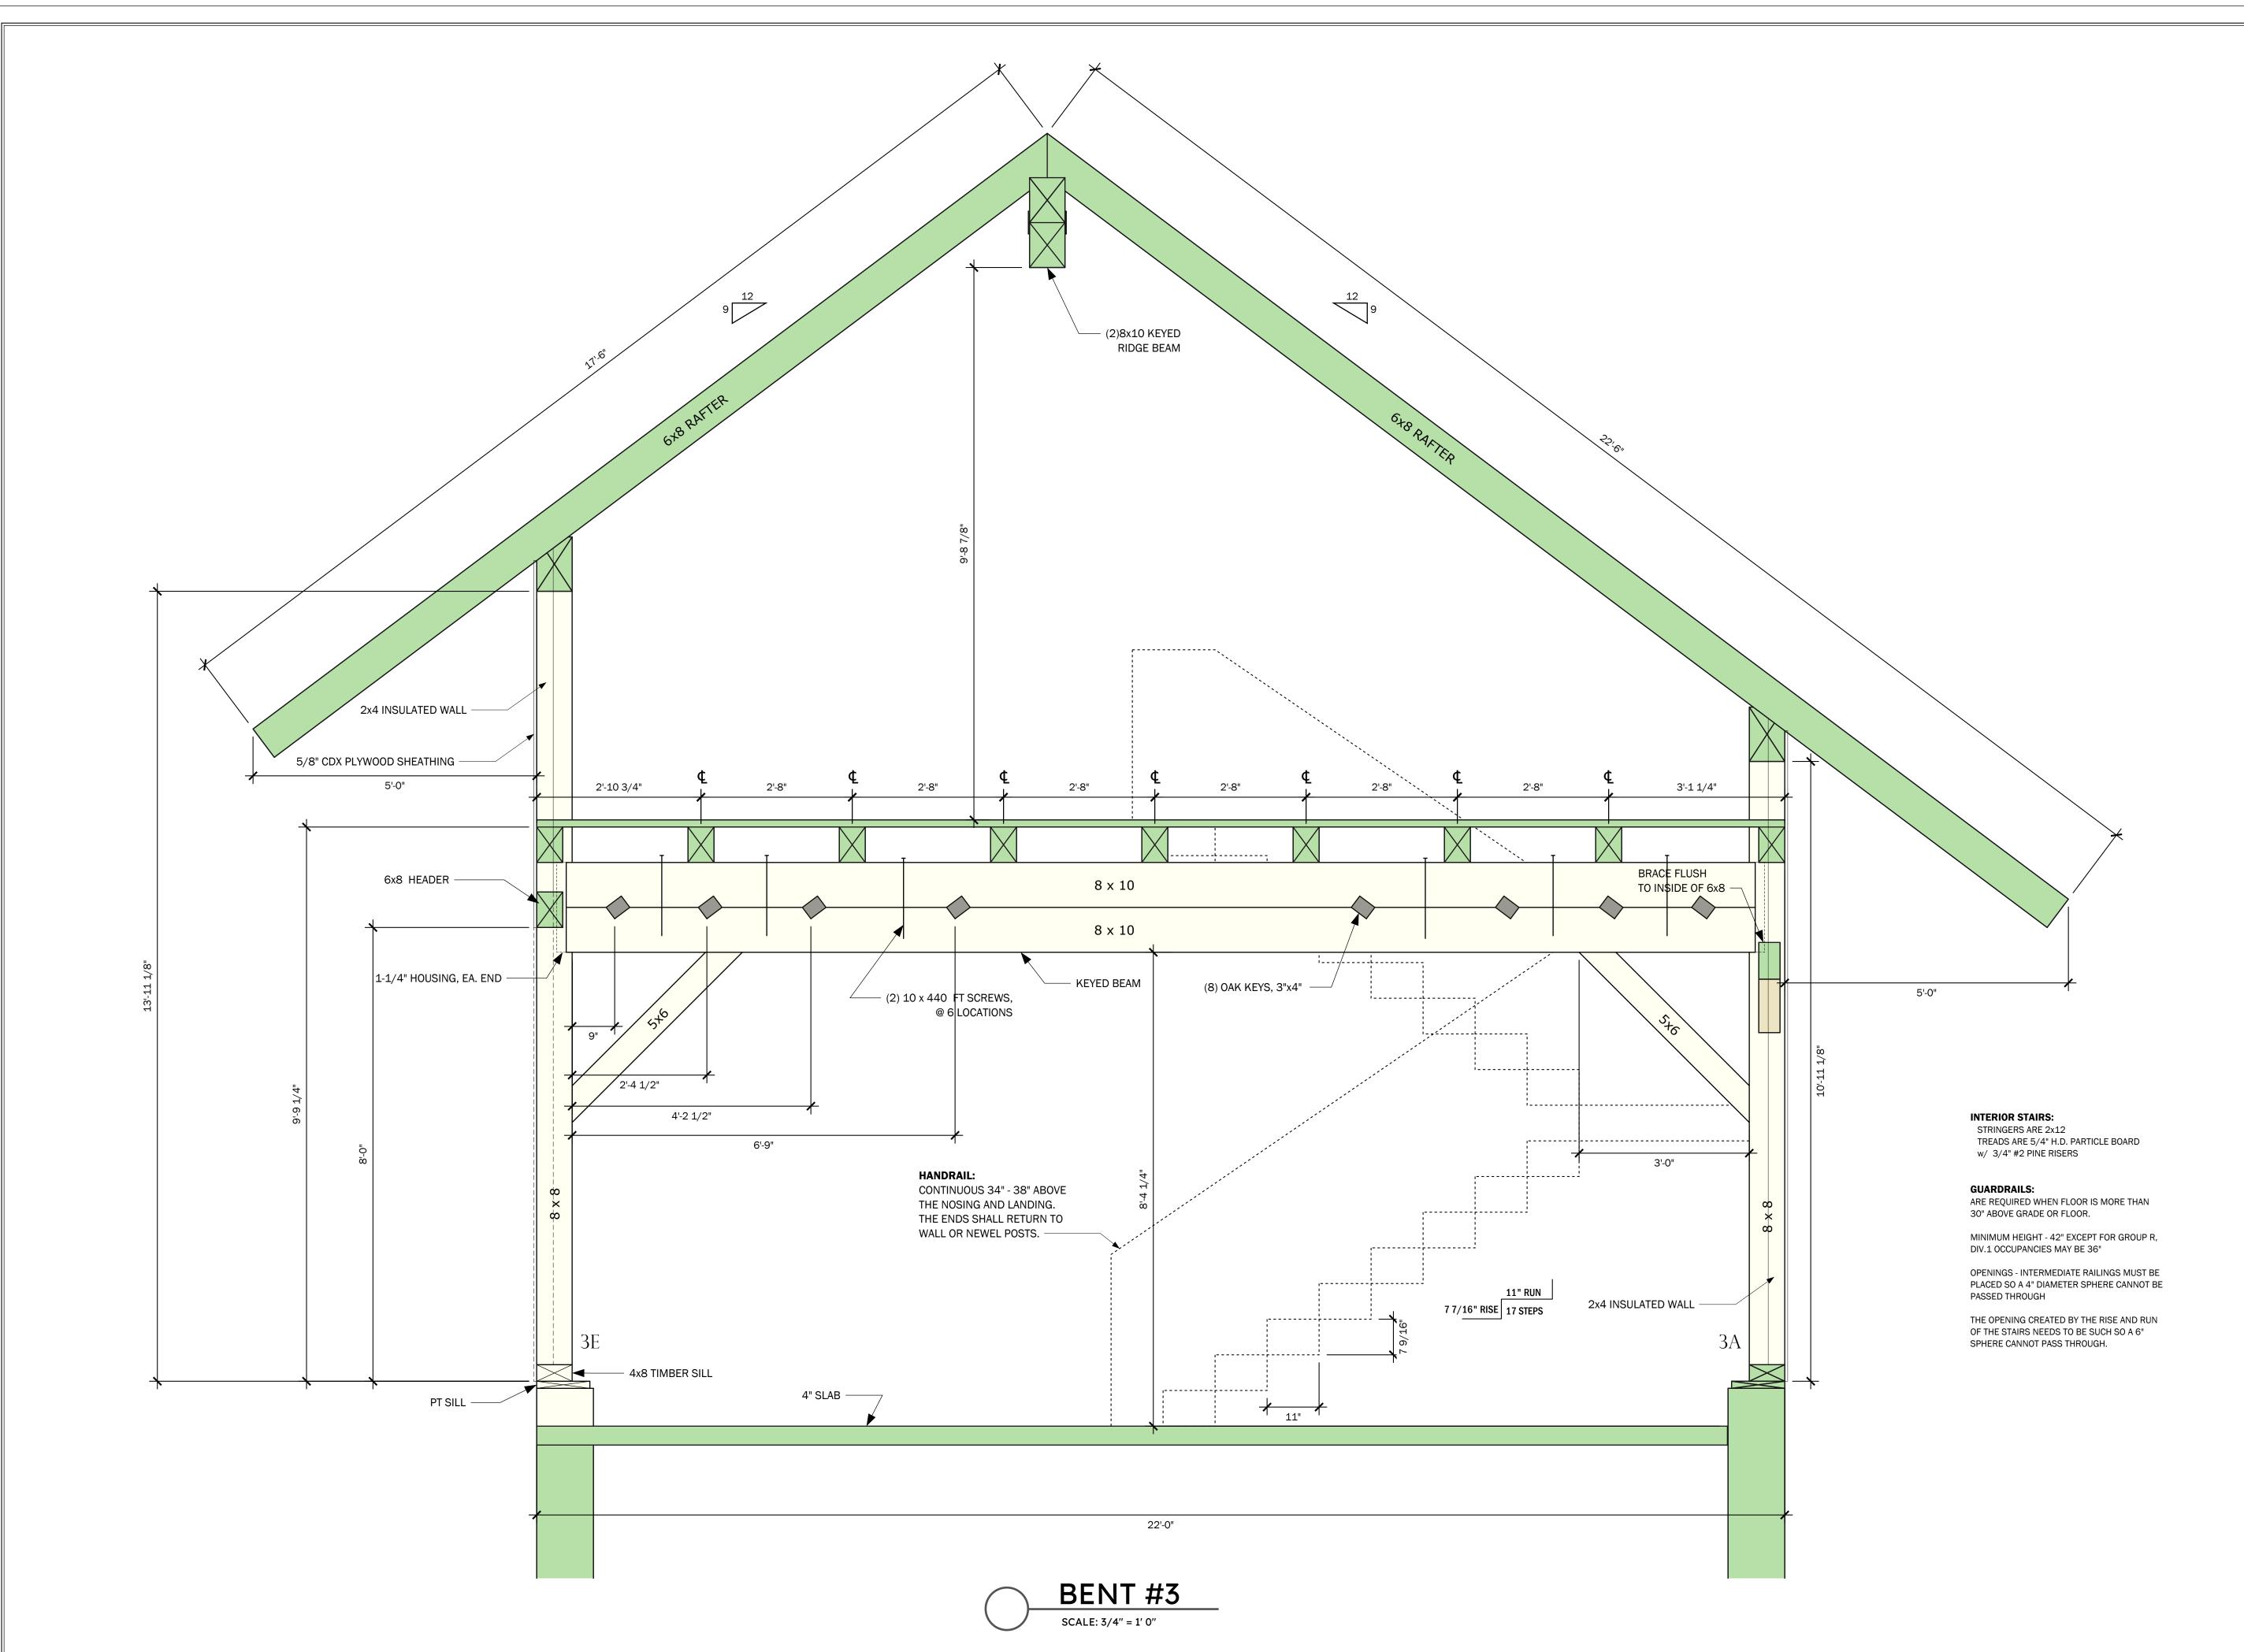



P.O. BOX 225
HARDWICK, MA 01037
PH: (413) 477-6430
Fax: (413) 477-0937
LIC. NO. 010089
WWW.HARDWICKPOSTANDBEAM.COM

PROPOSED PROJECT:

LEE GARAGE

CLIENT:

LEE, BARBARA 15 LAKE ROAD CHILMARK, MA

SITE INFO:

DEPINO / LEE CHILMARK / 15 LAKE ROAD

FILE NAME:	E NAME: HP&B BARBARALEE_CDs_06	
DATE MODIF	IED:	03-20-24
DRAWN BY:		GM
CHECKED BY	Y :	XXX
SCALE:		VARIES


ALL MATERIAL IS #1 OR BETTER. EASTERN WHITE PINE.

NO.	REVISIONS	DATE
1	CONCEPT	07-18-23
2	DAMROTH COMMENTS	08-08-23
3	KEYED BEAMS	09-27-23
4		

BENT 3

PAGE NUMBER

TF11 of 12

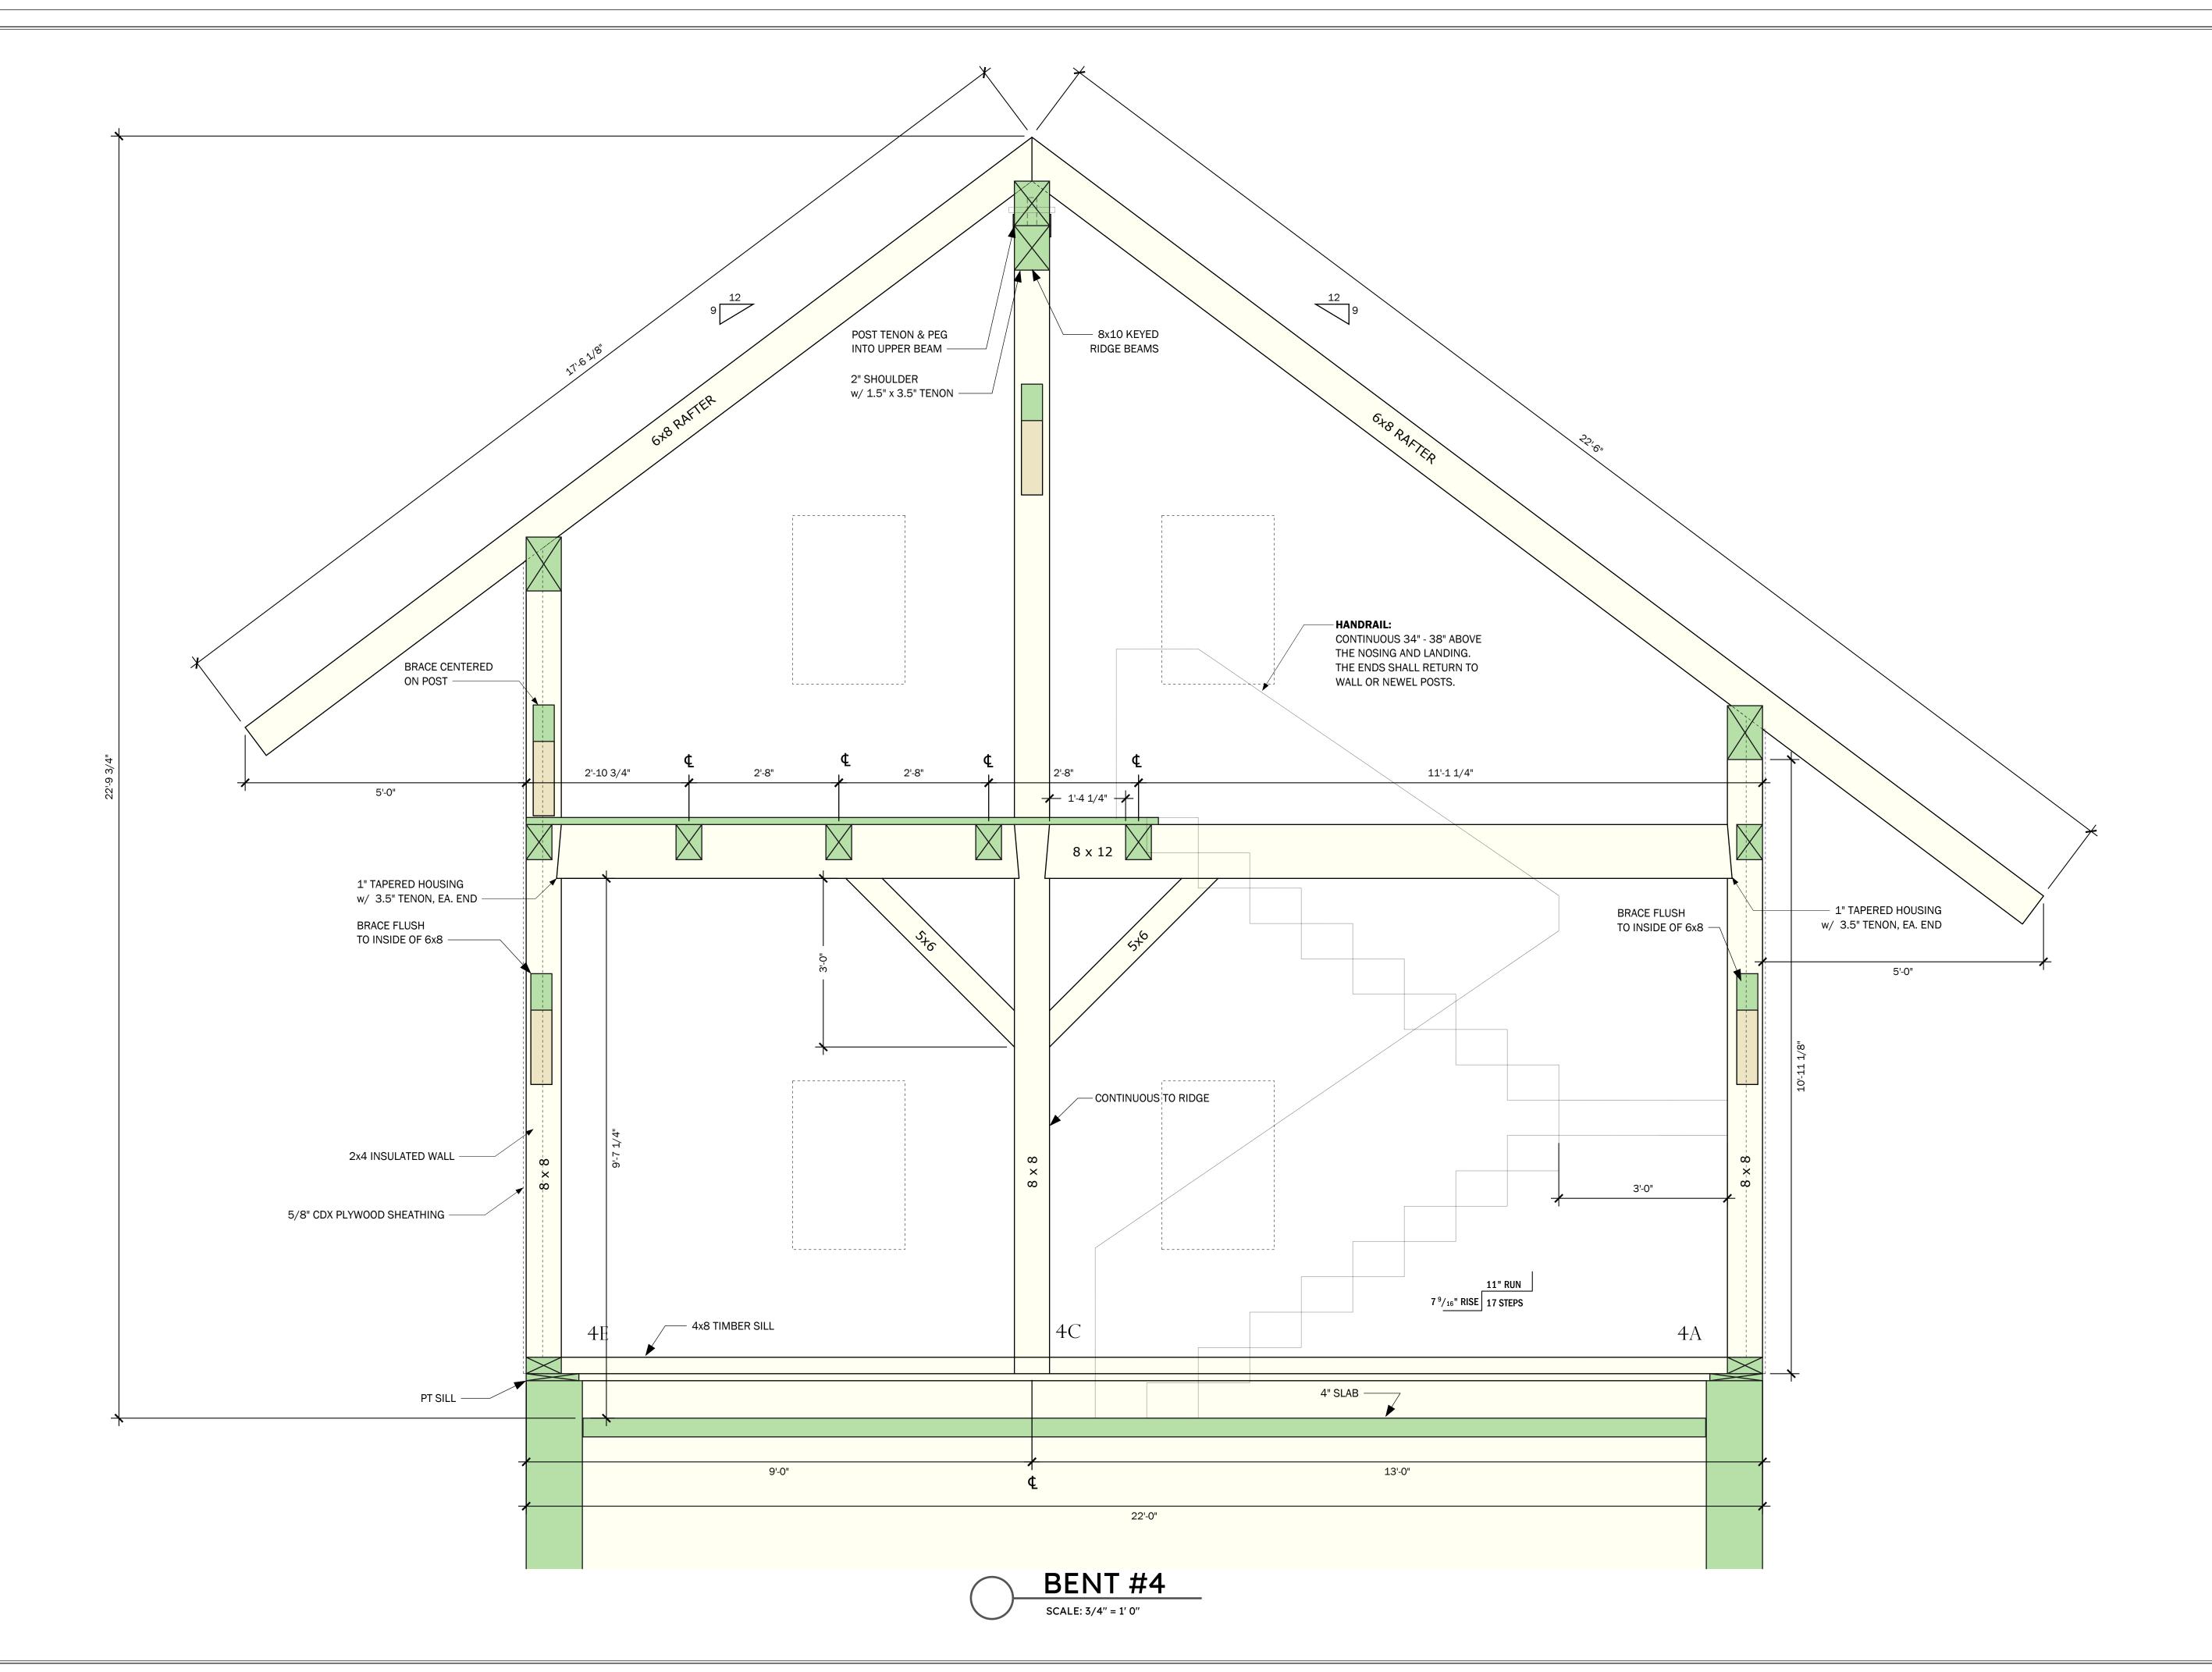



P.O. BOX 225
HARDWICK, MA 01037
Ph: (413) 477-6430
Fax: (413) 477-0937
Lic. No. 010089
WWW.HARDWICKPOSTANDBEAM.COM

PROPOSED PROJECT:

LEE GARAGE

CLIENT:

LEE, BARBARA 15 LAKE ROAD CHILMARK, MA

SITE INFO:

DEPINO / LEE CHILMARK / 15 LAKE ROAD

FILE NAME:	HP&B Barbar	ALEE_CDS_06
DATE MODIFIE	D:	03-20-24
DRAWN BY:		GM
CHECKED BY:		XXX
SCALE:		VARIES

ALL MATERIAL IS #1 OR BETTER. EASTERN WHITE PINE.

NO.	REVISIONS	DATE
1	CONCEPT	07-18-23
2	DAMROTH COMMENTS	08-08-23
3	KEYED BEAMS	09-27-23
4		

BENT 4

PAGE NUM

TF12 of 12